Public Document Pack



Northern Planning Committee Supplementary Agenda

Date: Wednesday 1st October, 2025

Time: 10.30 am

Venue: The Capesthorne Room - Town Hall, Macclesfield, SK10 1EA

5. 24/4391/FUL - LAND WEST OF ALDERLEY ROAD, WILMSLOW, SK9 1PZ: Demolition of existing buildings and erection of care home with associated parking, landscaping and access improvements (Pages 3 - 20)

Revised Key Plans.

6. 25/0676/FUL - ST GEORGES STREET BAPTIST CHURCH ST GEORGES STREET, MACCLESFIELD, SK11 6TG: Converting St Georges Street Baptist Church into 8 luxury apartments and a 6-bedroom House in Multiple Occupation (HMO) (Pages 21 - 34)

Revised Key Plans.

7. 25/1947/FUL - SHERWOOD, 33 ADLINGTON ROAD, WILMSLOW, SK9 2BJ: The creation of two new houses to the rear of the existing house 33 Adlington Road (Pages 35 - 44)


Revised Key Plans.


Please contact Rachel Graves

E-Mail: rachel.graves@cheshireeast.gov.uk



24/4391/FUL Land West of Alderley Road, Wilmslow, SK9 1PZ

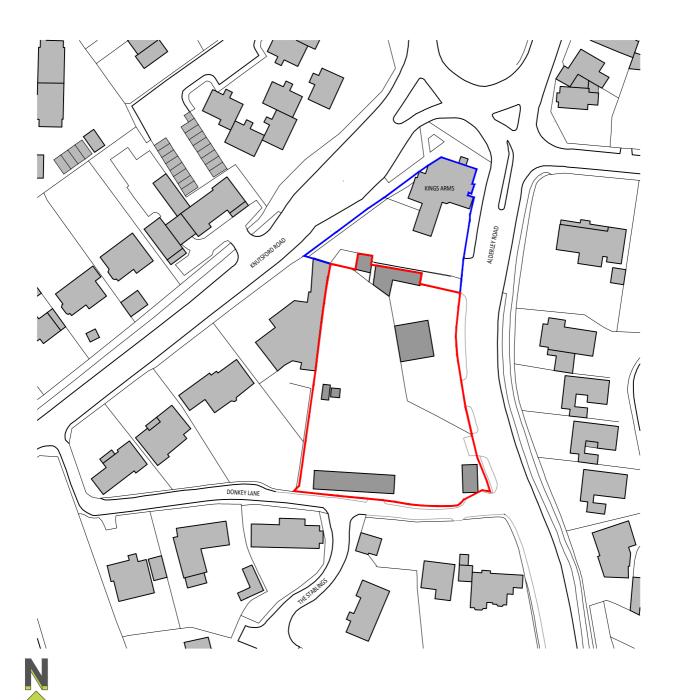

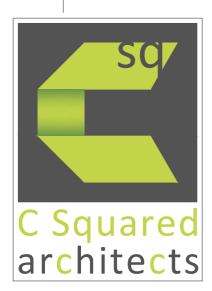


The Barns	Telephone
Stretton Road	01925 357555
Warrington	Website
WA4 4NP	csquaredarchitects.co.uk

This drawing is to be read in conjunction with all related Architect's and Engineer's drawings and any other relevant information.

This drawing is copyright © of C Squared Architects Ltd.

Α	24/09/24	Issued for Planning	HPC	HPC
В	08/10/24	Issued for Planning	HPC	HPC
	1	I	1	

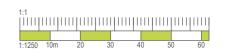

Client
McGoff Group Projects Ltd.
Project
Proposed Care Home
Alderley Road, Wilmslow
Drawing Title
Location Plan
Scale Date
1:1250 @ A4 09/09/24
Drawn by Checked by
HPC HPC
Drawing No. Revision
M0209-101 B
PLANNING
PLANNING







Do not scale, use figured dimensions only.

All dimensions to be verified on site prior to the commencement of any work or the production of any shop drawing. All discrepancies to be reported to the Architect. This drawing is to be read in conjunction with all related Architect's and Engineer's drawings and any other relevant

This drawing is copyright © of C Squared Architects Ltd.

REV	DATE	REVISION	INITIALS	CHECK
Α	24/09/24	Issued for Planning	JO	HPC
В	08/10/24	Issued for Planning	JO	HPC
С	08/09/25	Parking increased to suit planning committee comments	HPC	HPC





Address
The Barns
Stretton Road
Warrington
Cheshire
WA4 4NP

Client
McGoff Group Projects Ltd.

Proposed Care Home Alderley Road, Wilmslow

Proposed Coloured Site Plan

PI A N N	· ·
M0209 - 105	(
Drawing No.	Revisior
JO	HPO
Drawn by	Checked by
1:200 @ A1	14/08/2
Scale	Date

Window Heads

-Dark Grey

-Dark Grey

-Dark Grey

-Dark Grey

- Dark Grey

Dormers and Link

Louvre's






Do not scale, use figured dimensions only.

All dimensions to be verified on site prior to the commencement of any work or the production of any shop drawing. All discrepancies to be reported to the Architect.

This drawing is to be read in conjunction with all related Architect's and Engineer's drawings and any other relevant information.

This drawing is copyright © of C Squared Architects Ltd.

REV	DATE	REVISION		
Α	24/09/24	Issued for Planning	JO	HPC
В	11/10/24	Issued for Planning	JO	HPC

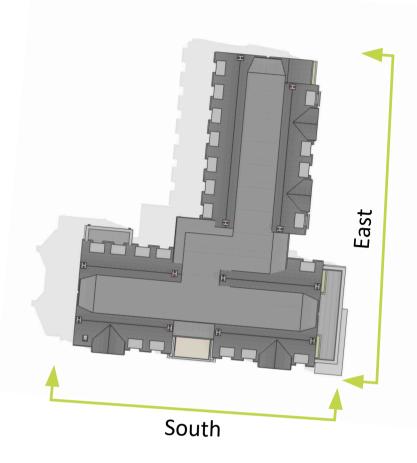

Material Finishes Facing brick Plinth and -Red Multi Bays - Darkish Red Multi Rainwater Goods Facing brick of Rear Building -Red Multi **Feature Panels**

-Timber Effect **Feature Chimneys** -Red Multi Roof

-Grey Composite Slate Building



Address The Barns Stretton Road Warrington Cheshire WA4 4NP

Telephone 01925 357555 csquaredarchitects.co.uk

McGoff Group Projects Ltd.

Alderley Road, Wilmslow

Elevations - Sheet 1 of 3

Scale	Date
1:100 @ A1	06/09/24
Drawn By	Checked By
JO	НРС
Drawing No.	Revision
M0209 - 120	В
PLAN	INING

JO HPC JO HPC

Do not scale, use figured dimensions only.

A 24/09/24 Issued for Planning

B 11/10/24 Issued for Planning

information.

All dimensions to be verified on site prior to the commencement

of any work or the production of any shop drawing. All discrepancies to be reported to the Architect.

This drawing is to be read in conjunction with all related Architect's and Engineer's drawings and any other relevant

This drawing is copyright © of C Squared Architects Ltd.

Feature Chimneys -Dark Grey **Dormers and Link** -Grey Composite Slate Building - Dark Grey



Facing brick of Rear

Building

-Red Multi

-Red Multi

Roof

Feature Panels

-Timber Effect

The Barns Stretton Road Warrington Cheshire WA4 4NP

Address

Telephone 01925 357555 csquaredarchitects.co.uk

McGoff Group Projects Ltd.

Alderley Road, Wilmslow

Elevations - Sheet 2 of 3

06/09/24 1:100 @ A1 HPC

M0209 - 121 **PLANNING**





Window Heads

-Dark Grey

-Dark Grey

Windows, Doors






Do not scale, use figured dimensions only.

All dimensions to be verified on site prior to the commencement of any work or the production of any shop drawing. All discrepancies to be reported to the Architect.

This drawing is to be read in conjunction with all related Architect's and Engineer's drawings and any other relevant information.

This drawing is copyright © of C Squared Architects Ltd.

REV	DATE	REVISION		
Α	24/09/24	Issued for Planning	JO	HPC
В	11/10/24	Issued for Planning	JO	HPC
С	13/08/25	Missing Window Added to West Elevation	JO	HPC

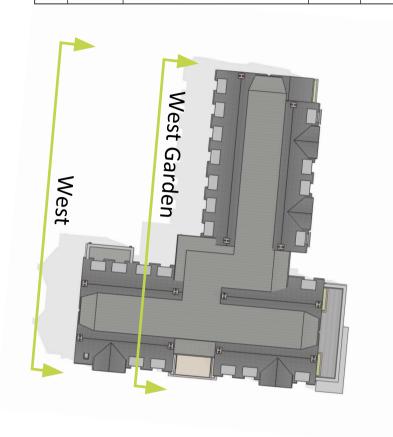

Material Finishes Facing brick Plinth and -Red Multi Bays - Darkish Red Multi Rainwater Goods Facing brick of Rear Building -Red Multi **Feature Panels** -Timber Effect

-Dark Grey **Feature Chimneys** Louvre's -Red Multi -Dark Grey Roof **Dormers and Link**

-Grey Composite Slate Building - Dark Grey



Address The Barns Stretton Road Warrington Cheshire WA4 4NP

Telephone 01925 357555

architects

Website csquaredarchitects.co.uk

McGoff Group Projects Ltd.

Alderley Road, Wilmslow

Elevations - Sheet 3 of 3

Scale	Date
1:100 @ A1	06/09/24
Drawn By	Checked By
JO	HPC
Drawing No.	Revision
M0209 - 122	С
PLANN	IING

Do not scale, use figured dimensions only.

All dimensions to be verified on site prior to the commencement


of any work or the production of any shop drawing. All discrepancies to be reported to the Architect.

This drawing is to be read in conjunction with all related Architect's and Engineer's drawings and any other relevant

This drawing is copyright © of C Squared Architects Ltd.




South Site Section

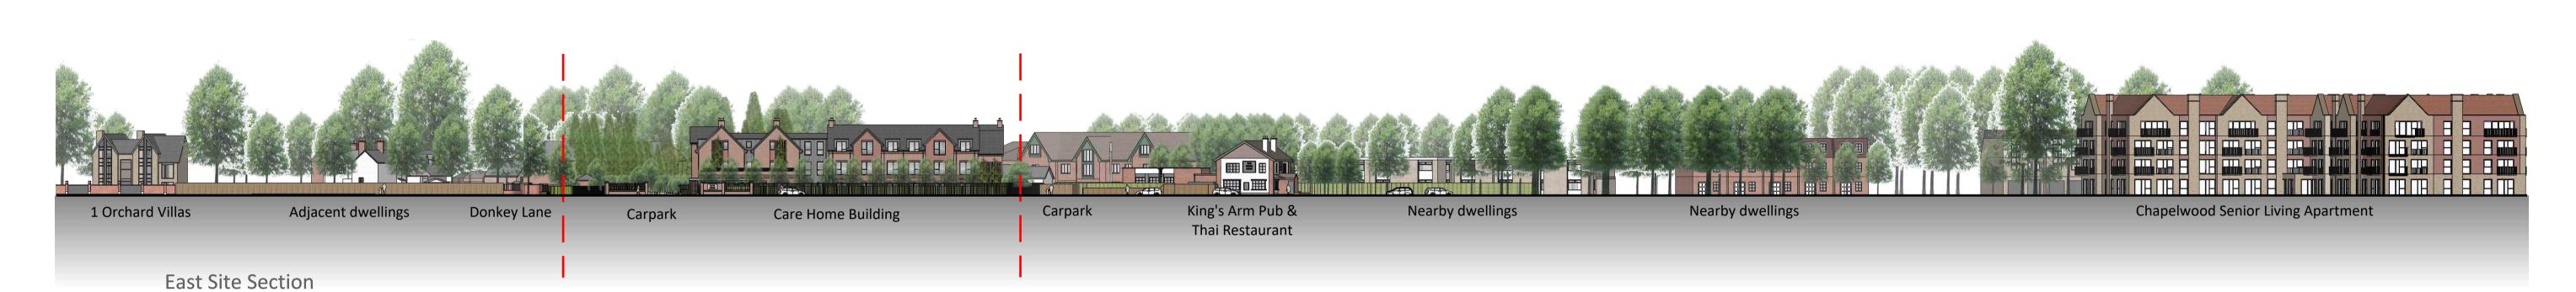





Address The Barns

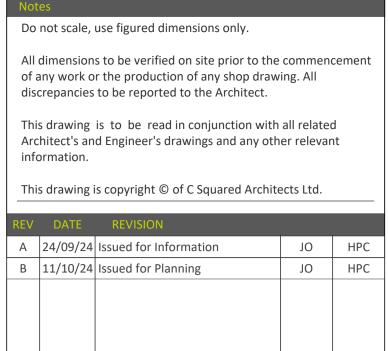





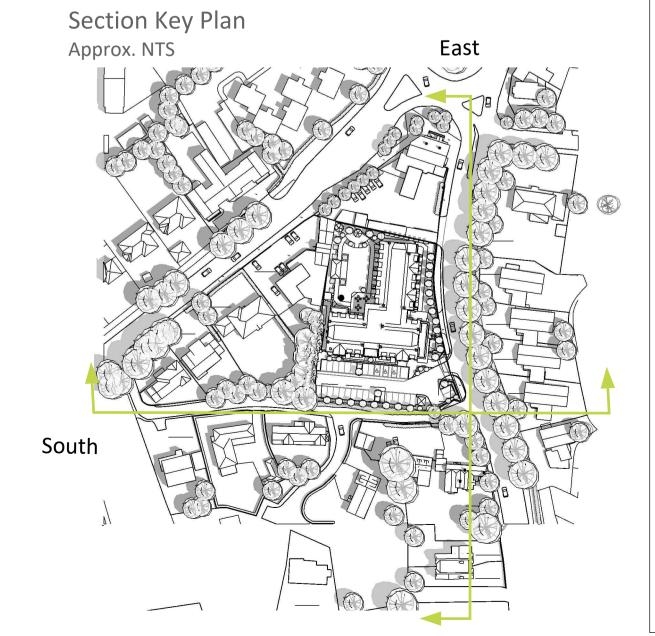

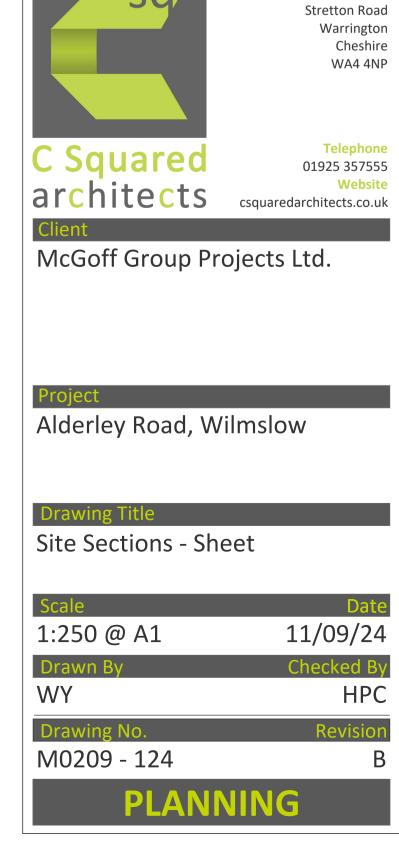

Do not scale, use figured dimensions only.

discrepancies to be reported to the Architect.

A 24/09/24 Issued for Planning

B 11/10/24 Issued for Planning

information.

All dimensions to be verified on site prior to the commencement of any work or the production of any shop drawing. All

This drawing is to be read in conjunction with all related Architect's and Engineer's drawings and any other relevant

C 08/09/25 Bedroom types amended to suit planning committee comments HPC HPC

HPC HPC

JO HPC

This drawing is copyright © of C Squared Architects Ltd.



*≫*Bedroom

18.8m²

Bedroom

Bedroom

18.8m²

Louvre `

Service Entrance

E/E



Do not scale, use figured dimensions only.

All dimensions to be verified on site prior to the commencement of any work or the production of any shop drawing. All discrepancies to be reported to the Architect.

This drawing is to be read in conjunction with all related Architect's and Engineer's drawings and any other relevant information.

This drawing is copyright © of C Squared Architects Ltd.

REV	DATE	REVISION	INITIALS	CHECK
Α	24/09/24	Issued for Planning	HPC	HPC
В	11/10/24	Issued for Planning	JO	HPC
С	08/09/25	Bedroom types amended to suit planning committee comments	HPC	HPC



HPC

M0209 - 111

PLANNING

Address

The Barns Stretton Road

Warrington

Telephone 01925 357555

Website

Date

09/09/24

Checked by

Cheshire

Do not scale, use figured dimensions only.

discrepancies to be reported to the Architect.

All dimensions to be verified on site prior to the commencement of any work or the production of any shop drawing. All

This drawing is to be read in conjunction with all related

HPC HPC



Wet room Bedroom 18.8m² Bedroom 18.8m² Wet room

Twin Bedroom (Subject to Fire Officer acceptance of 2 beds in a room)
Located on ground and
first floor
Total = 1-2no.


Connecting Bedrooms


Located on ground


and first floor

Total = 1-2no.



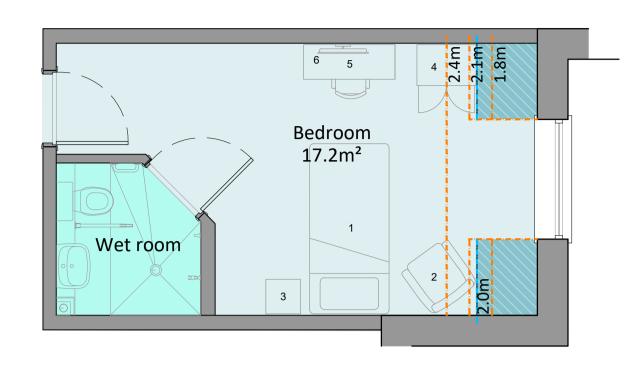

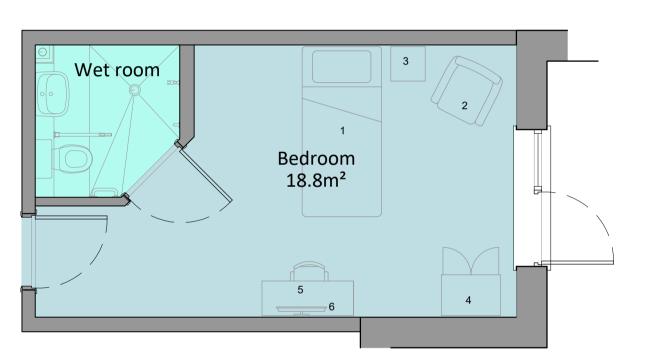

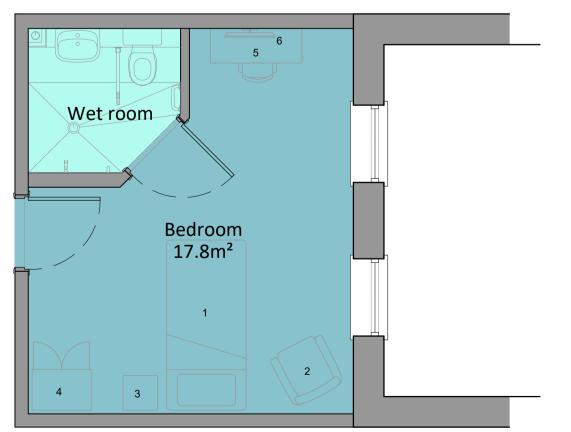

Dormer Bedrooms Located on second floor


Total = 19no.

Typical Bedrooms Located on ground, first and second floors Total = 40no.

Wider Bedrooms Located on ground,

Total = 3no.

first and second floors

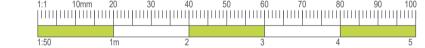

Do not scale, use figured dimensions only.

A 08/09/25 Issued for Planning

Furniture Legend

Specialist Bed

3. Bedside Table

Dressing Table

8. Dining Table

subject to building tolerances.

Please Note: Bedroom areas listed are exclusive of en-suite wet rooms and any parts of the room

on second floor below 2m in height. All areas are

2. Armchair

4. Wardrobe

6. TV

7. Sofa

9. Desk

information.

All dimensions to be verified on site prior to the commencement of any work or the production of any shop drawing. All discrepancies to be reported to the Architect.

This drawing is to be read in conjunction with all related Architect's and Engineer's drawings and any other relevant


HPC HPC

This drawing is copyright © of C Squared Architects Ltd.




PLANNING

M0209 - 113

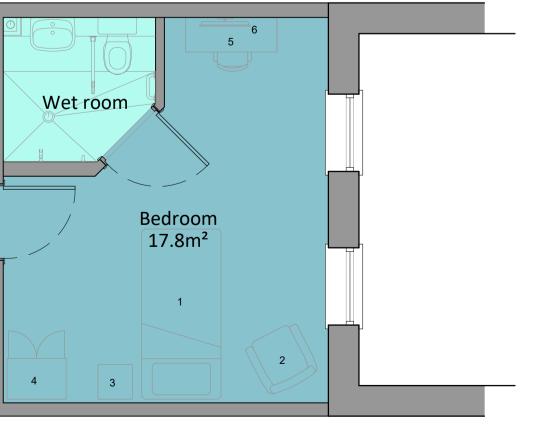



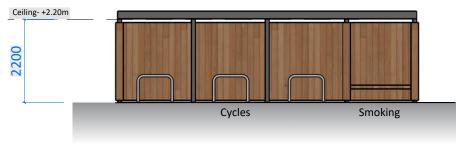


03. Elevation 1



04. Elevation 2



01. Roof Plan

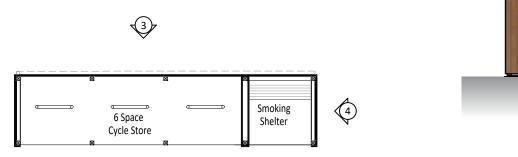





06. Elevation 4




1

2



This drawing is copyright © of C Squared Architects Ltd.

01. Roof Plan

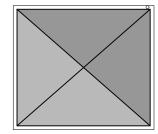







03. Elevation 1

04. Elevation 2

02. Floor Plan

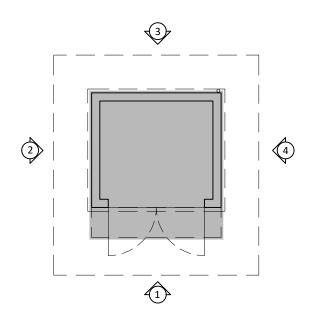



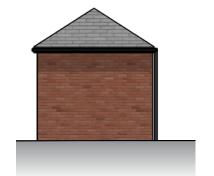

05. Elevation 3 06. Elevation 4





Note

Do not scale, use figured dimensions of

All dimensions to be verified on site prior to the commencement of any work or the production of any shop drawing. Al discrepancies to be reported to the Architect.

This drawing is to be read in conjunction with all rela Architect's and Engineer's drawings and any other relev information.

This drawing is copyright © of C Squared Architects Ltd.

Α	24/09/24	Issued for Planning	JO	HPC
В	11/10/24	Issued for Planning	JO	HPC

This page is intentionally left blank

25/0676/FUL

St Georges Street Baptist Church, St Georges Street, Macclesfield,

SK11 6TG




Date Produced: 19-Feb-2025



Planning Portal Reference: PP-13785889v1



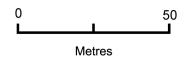





www.Tom-Ford-Architecture.com

notes

- Drawings are based on survey data and may not accurately represent what is physically present.
- Do not scale from this drawing. All dimensions to be site verified by the contractor before proceeding.
 All dimensions are in millimetres unless noted otherwise.
- All dimensions are in millimetres unless noted otherwise.
 Tom Ford Architecture Ltd shall be notified in writing of any discrepancies.
- 5. The copyright of this drawing is vested in Tom Ford Architecture Ltd and it may not be reproduced in whole or part or used for the manufacture of any article without the express permission of the copyright
- 6. This drawing is to be read in conjunction with all relevant engineers and consultants drawings and specifications.

REV	DATE	DRAWN BY	APPR. BY	NOTES	

ELIVI Property Group

St Georges Baptist Church

status: Stage 3
revision:

Proposed Block Plan

 drawn by:
 TJF


 approved by:
 TJF

 date:
 23.01.25

 job no:
 107

 scale:
 1:500@A1L



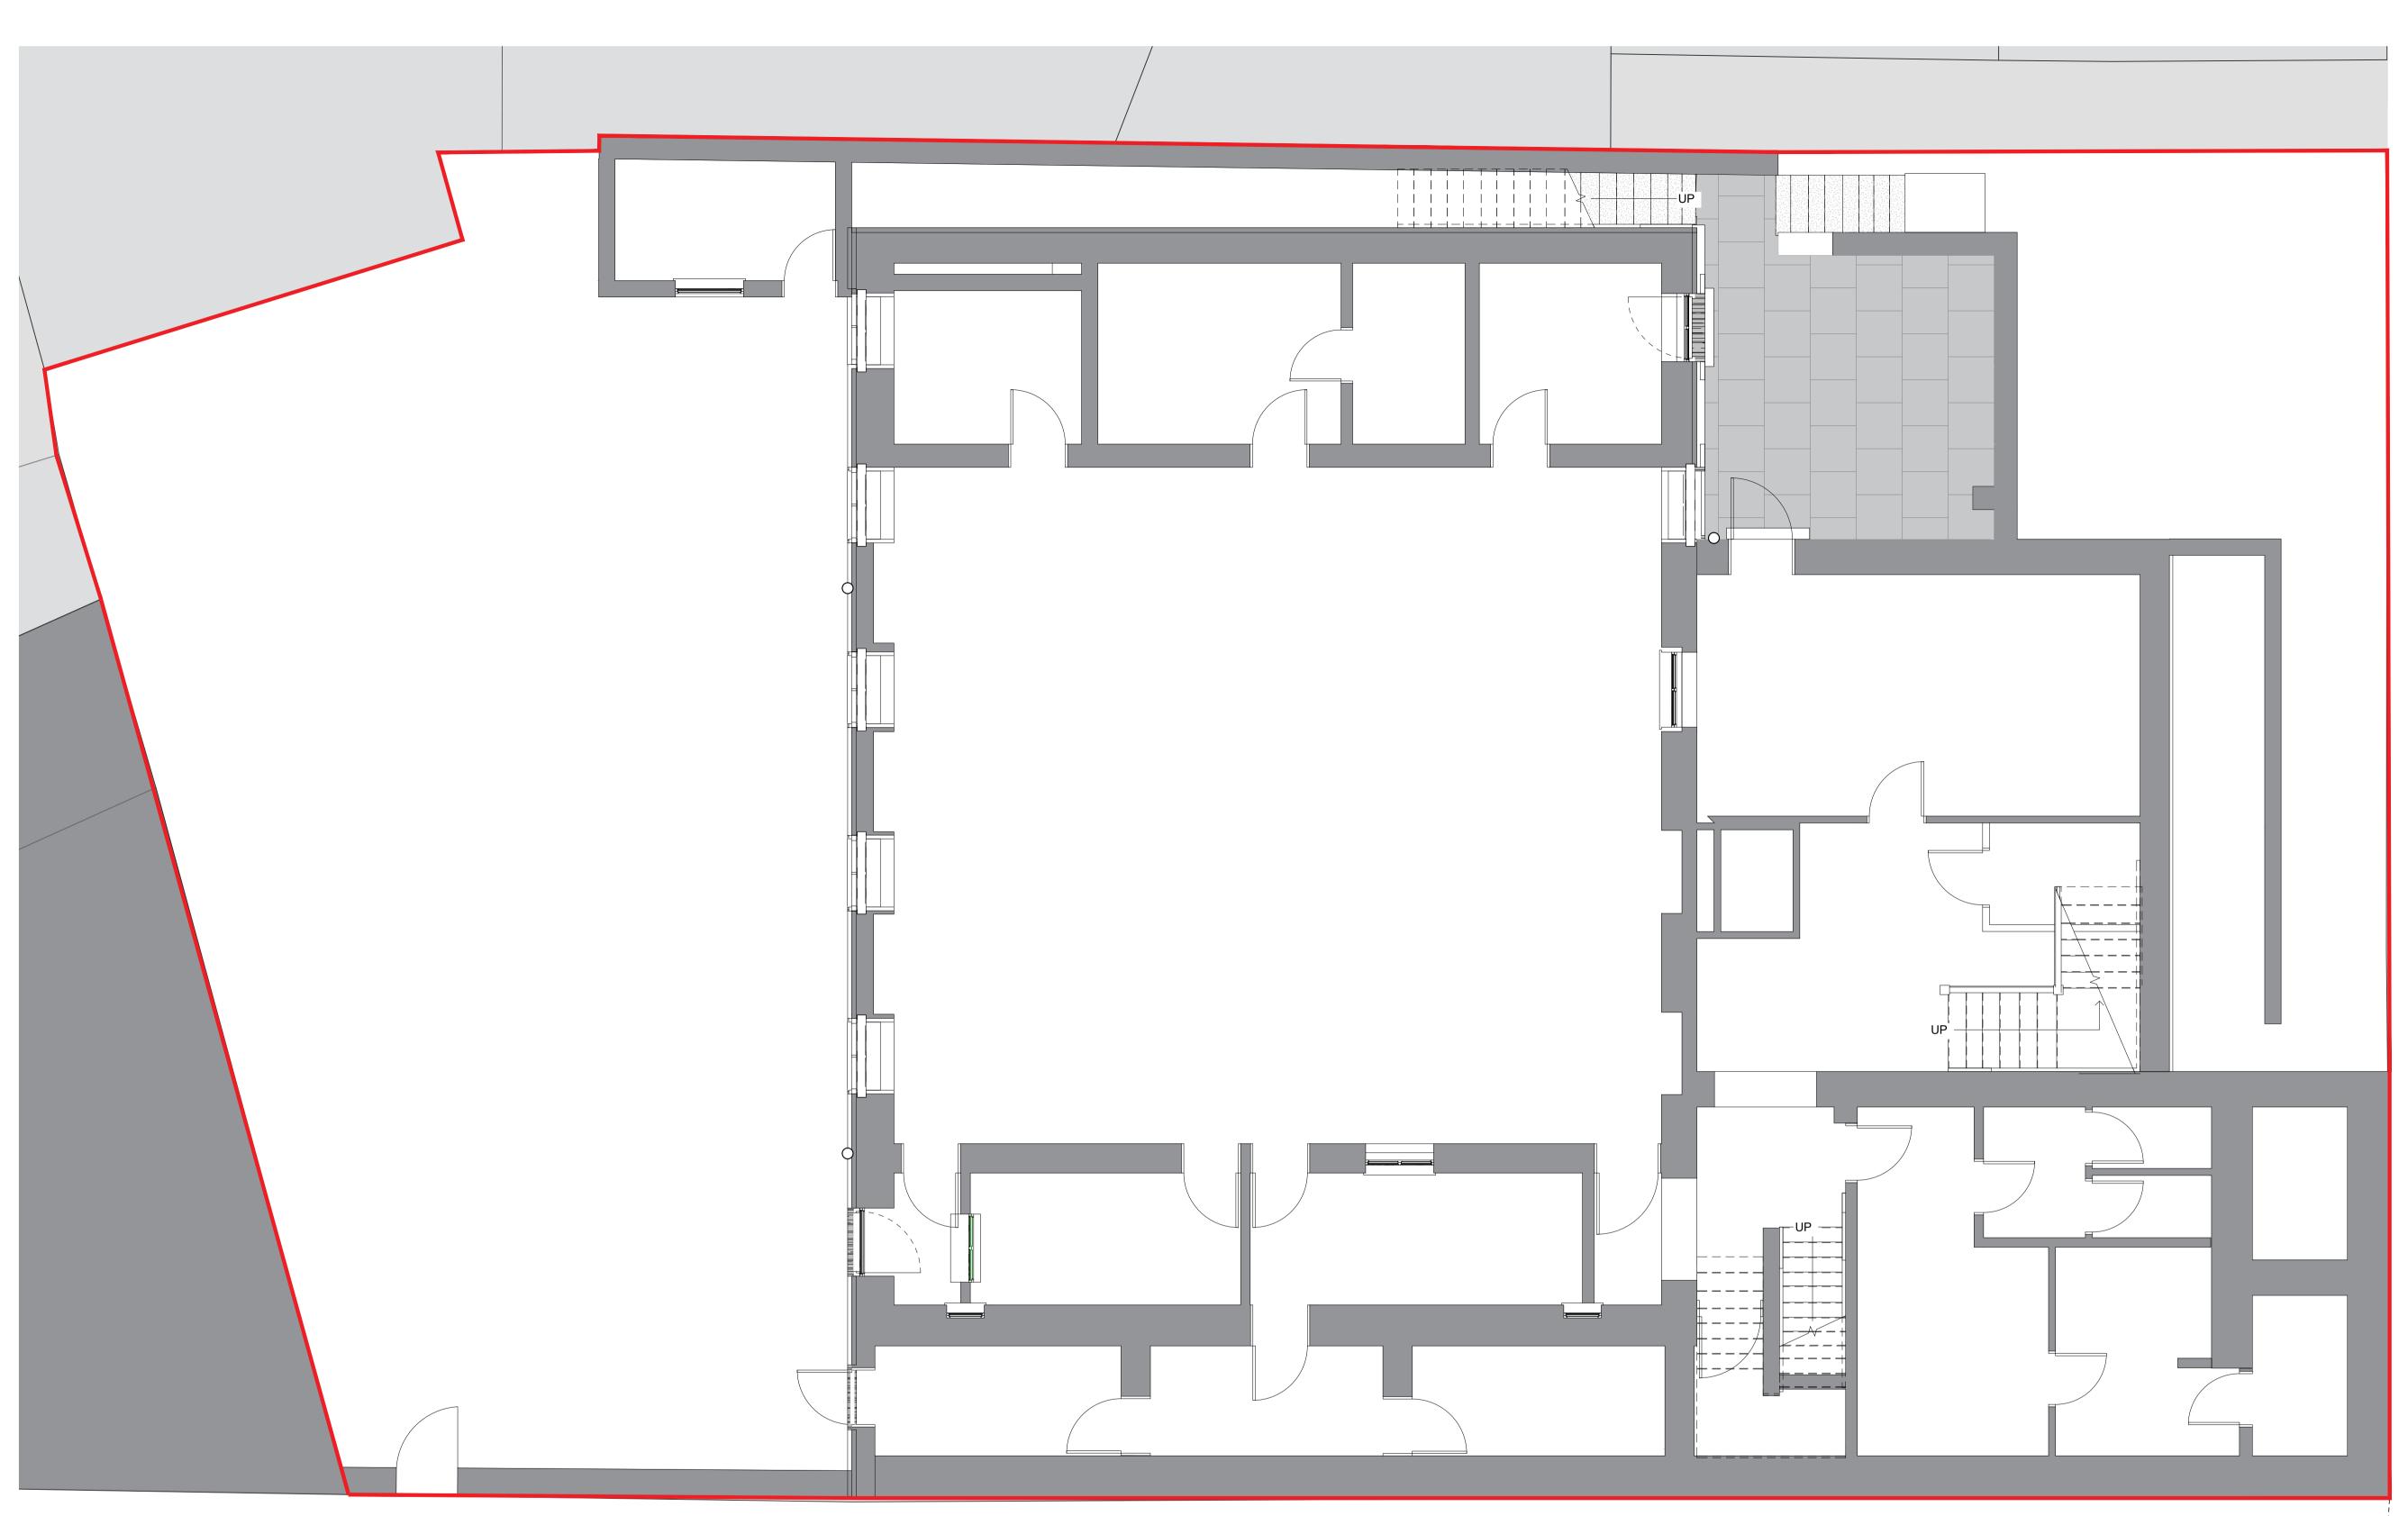




drawing no:



Tom Ford Architecture Ltd 22 Doreen Avenue Congleton, Cheshire

Tom@Tom-Ford-Architecture.com +7794019160 www.Tom-Ford-Architecture.com

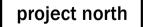

notes

- Drawings are based on survey data and may not accurately represent what is physically present.
- Do not scale from this drawing. All dimensions to be site verified by the contractor before proceeding. All dimensions are in millimetres unless noted otherwise.
- Tom Ford Architecture Ltd shall be notified in writing of any discrepancies. The copyright of this drawing is vested in Tom Ford Architecture Ltd and it may not be reproduced in whole or part or used for the manufacture of any article without the express permission of the copyright
- This drawing is to be read in conjunction with all relevant engineers and consultants drawings and specifications.





client: **ELIVI Property Group** project:

St Georges Baptist Church S2 - Concept status: revision:

title: **Existing GA Plan**


Lower Ground Floor TJF drawn by: TJF approved by: 16.12.24 date: 107 job no: 1:50@A1L scale:

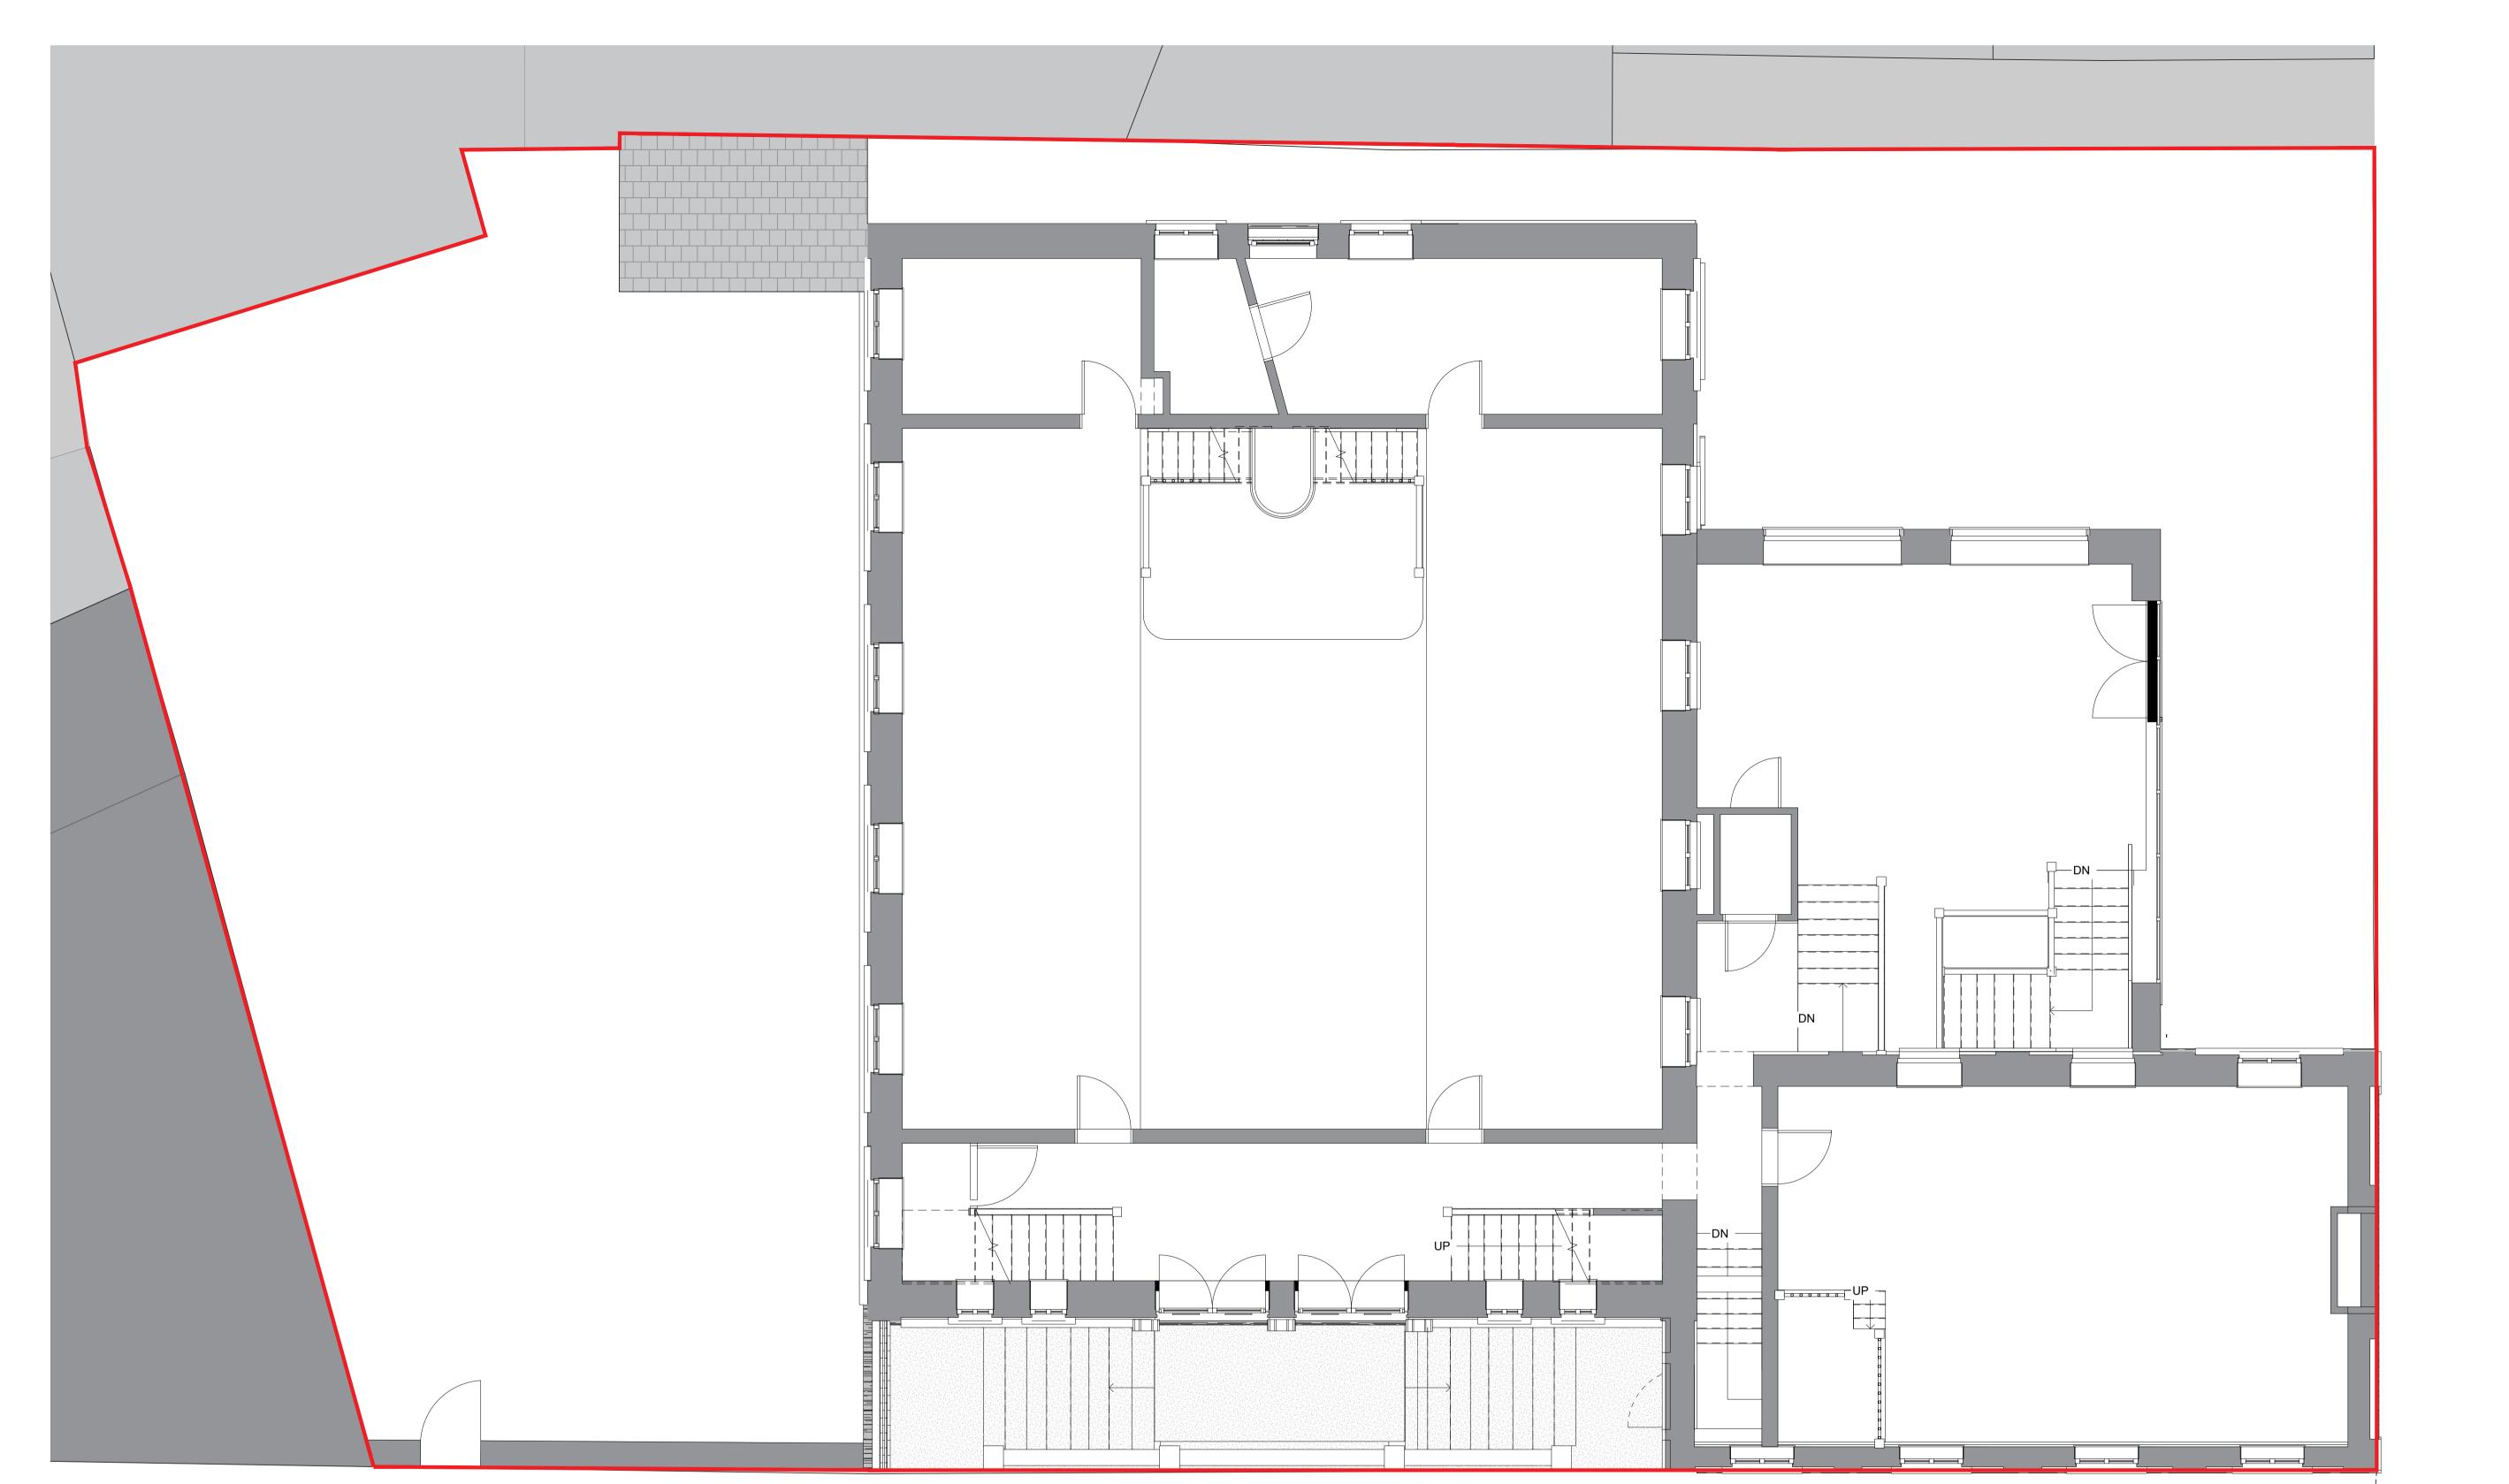

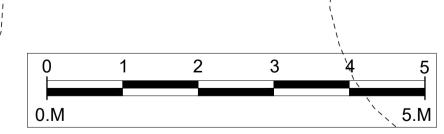




Tom@Tom-Ford-Architecture.com +7794019160 www.Tom-Ford-Architecture.com

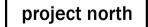

notes


- Drawings are based on survey data and may not accurately represent what is physically present.
- Do not scale from this drawing. All dimensions to be site verified by the contractor before proceeding. All dimensions are in millimetres unless noted otherwise.
- Tom Ford Architecture Ltd shall be notified in writing of any discrepancies.
- The copyright of this drawing is vested in Tom Ford Architecture Ltd and it may not be reproduced in whole or part or used for the manufacture of any article without the express permission of the copyright
- This drawing is to be read in conjunction with all relevant engineers and consultants drawings and specifications.

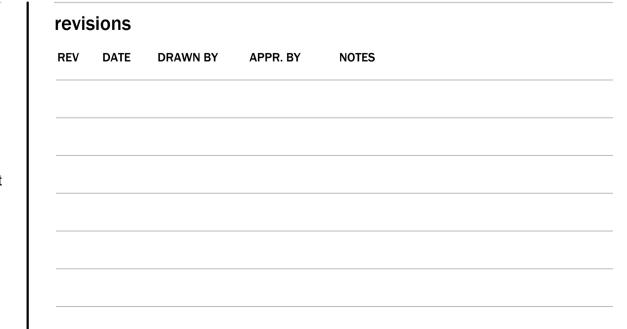


client: **ELIVI Property Group** project: St Georges Baptist Church STAGE 3 status:

revision:


title:	
	Existing GA Plan Ground Floor
drawn by:	TJF
approved by:	TJF
date:	16.12.24
job no:	107
scale:	1:50@A1L

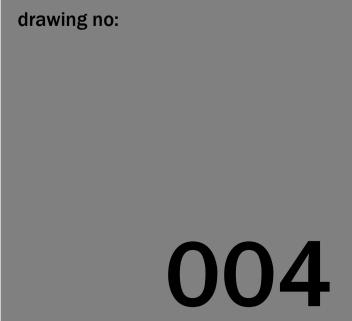

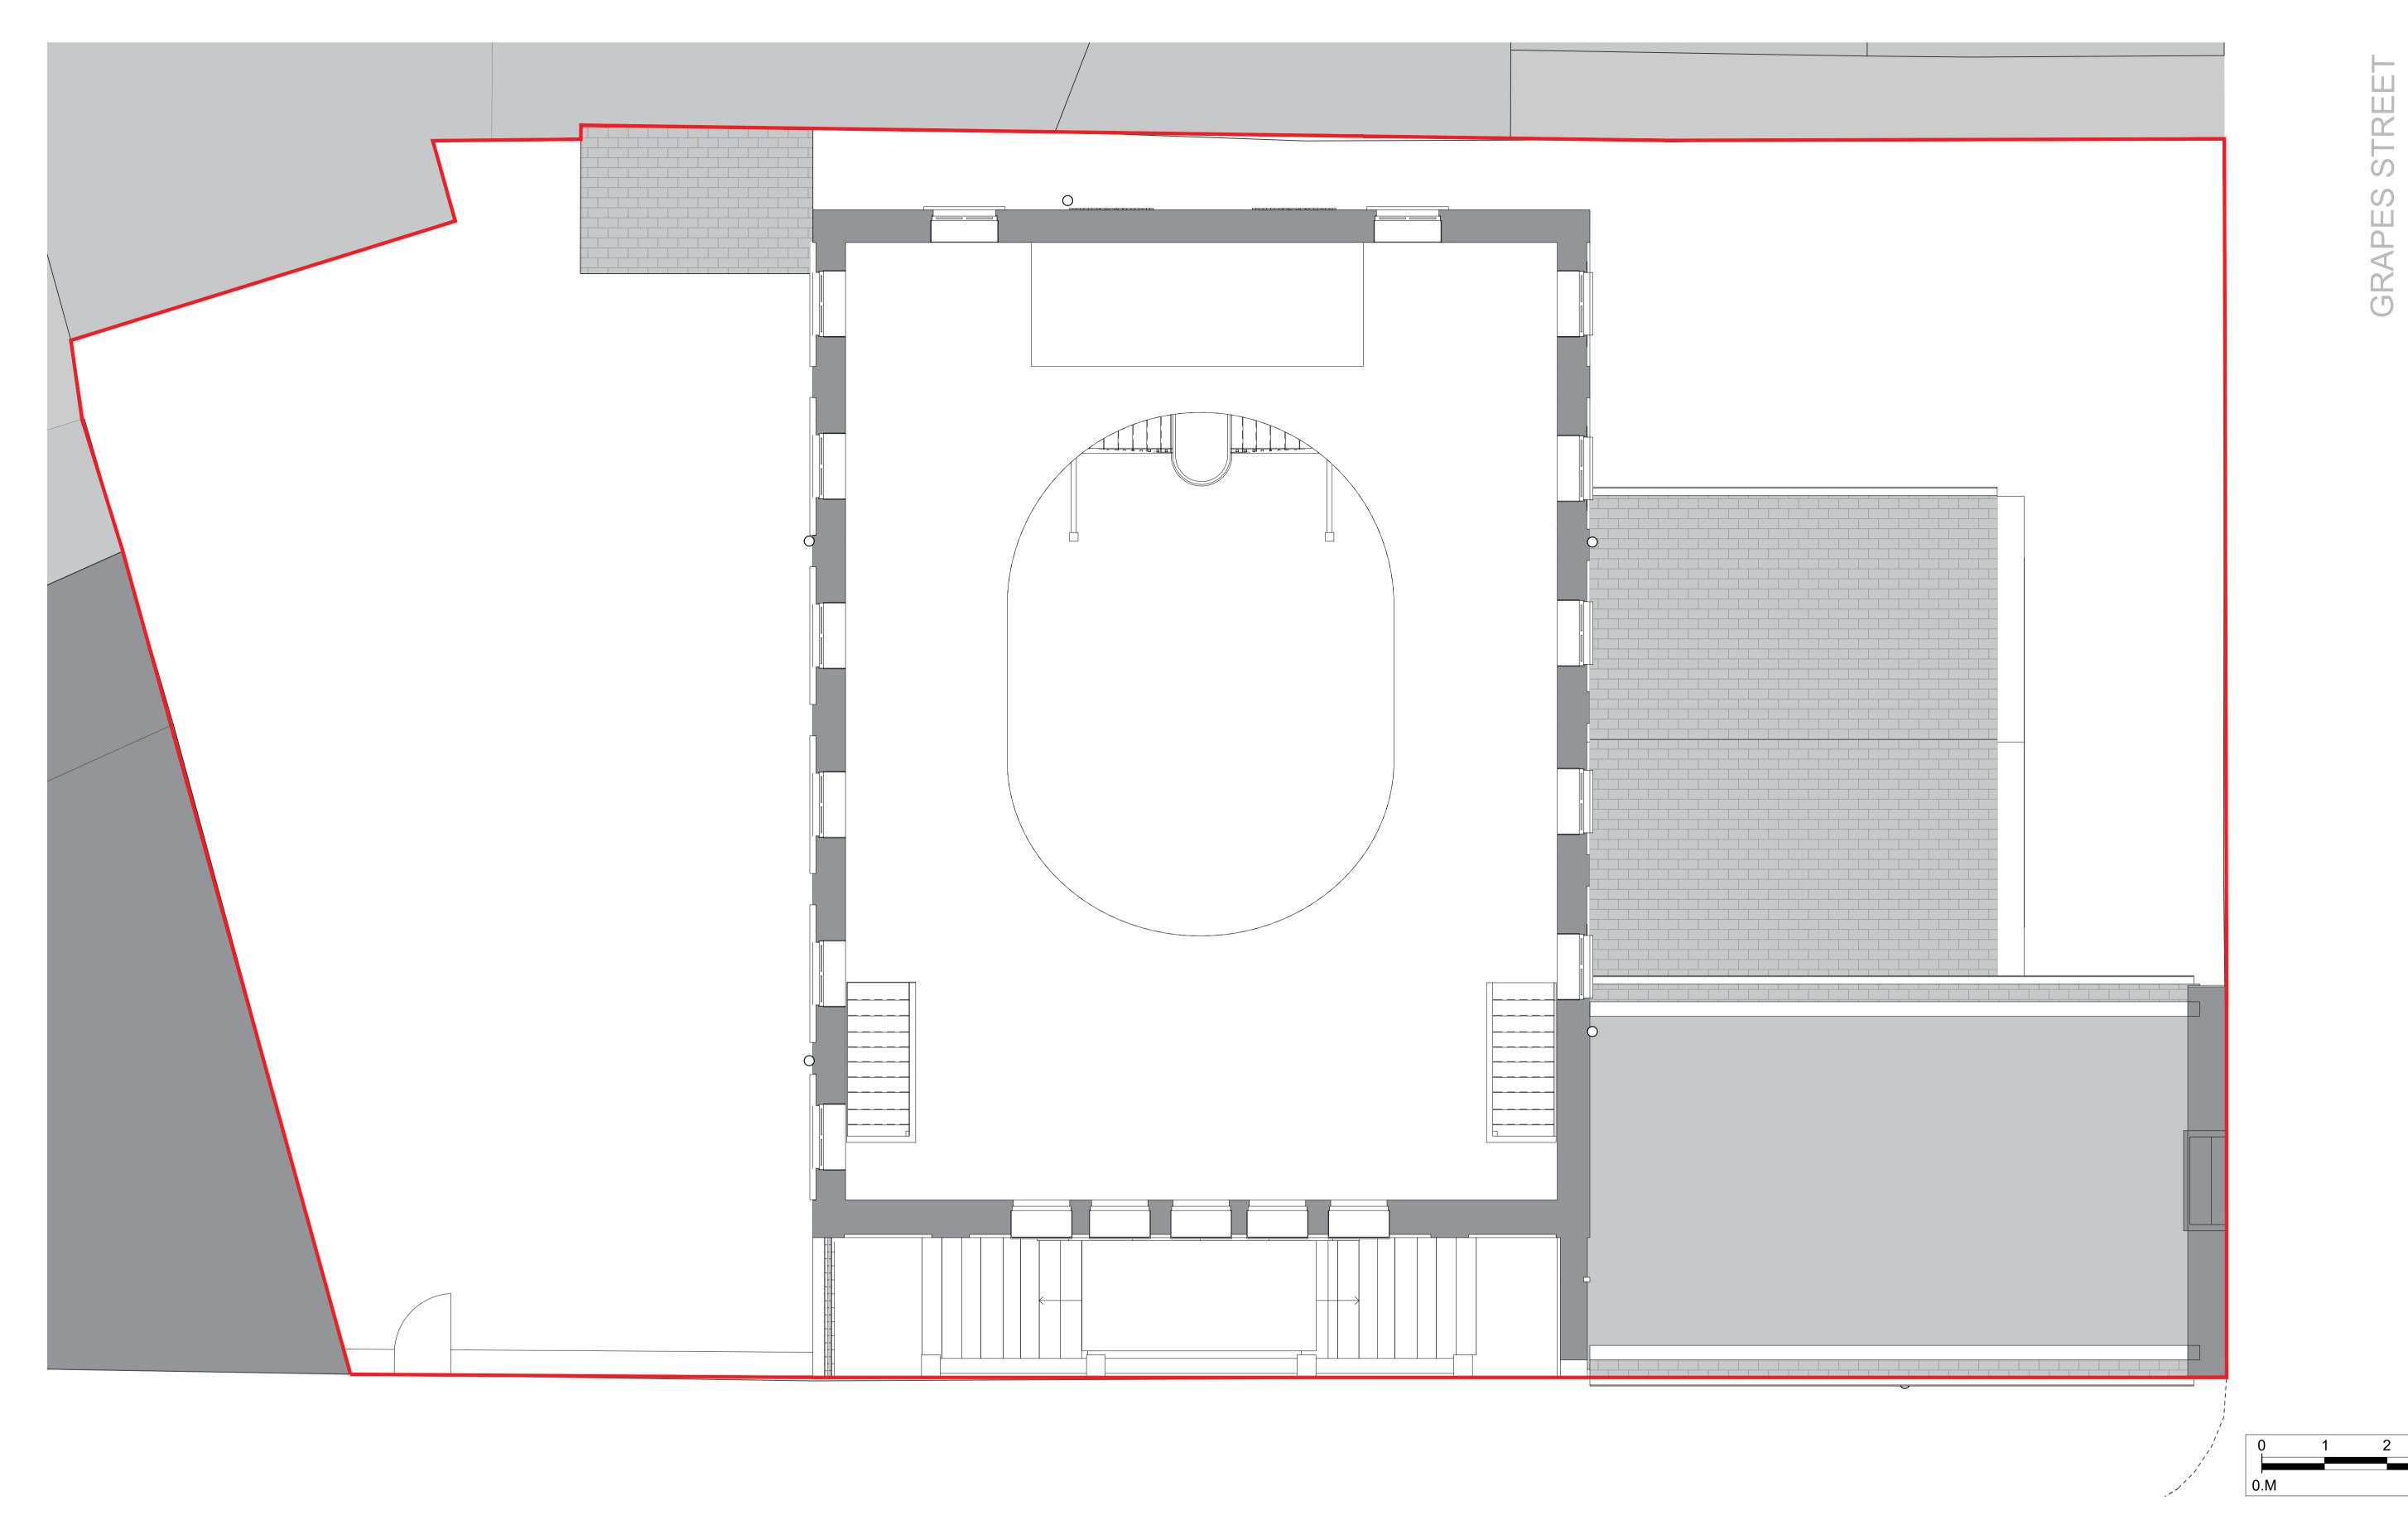




Tom@Tom-Ford-Architecture.com +7794019160 www.Tom-Ford-Architecture.com

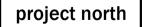

notes

- Drawings are based on survey data and may not accurately represent what is physically present.
- Do not scale from this drawing. All dimensions to be site verified by the contractor before proceeding. All dimensions are in millimetres unless noted otherwise.
- Tom Ford Architecture Ltd shall be notified in writing of any discrepancies.
- The copyright of this drawing is vested in Tom Ford Architecture Ltd and it may not be reproduced in whole or part or used for the manufacture of any article without the express permission of the copyright
- This drawing is to be read in conjunction with all relevant engineers and consultants drawings and specifications.

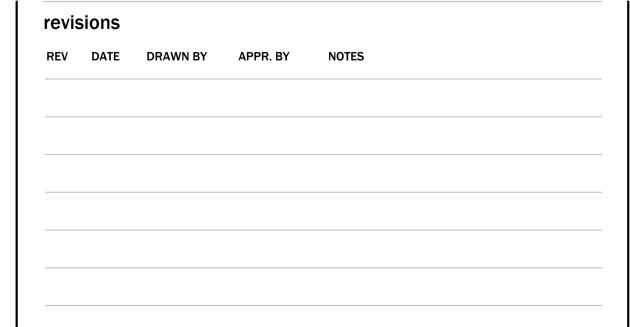


client: **ELIVI Property Group** project: St Georges Baptist Church STAGE 3 status:

revision:

title:	
	Existing GA Pla First Floo
drawn by:	TJ
approved by:	ΤJ
date:	16.12.2
job no:	10
scale:	1:50@A1




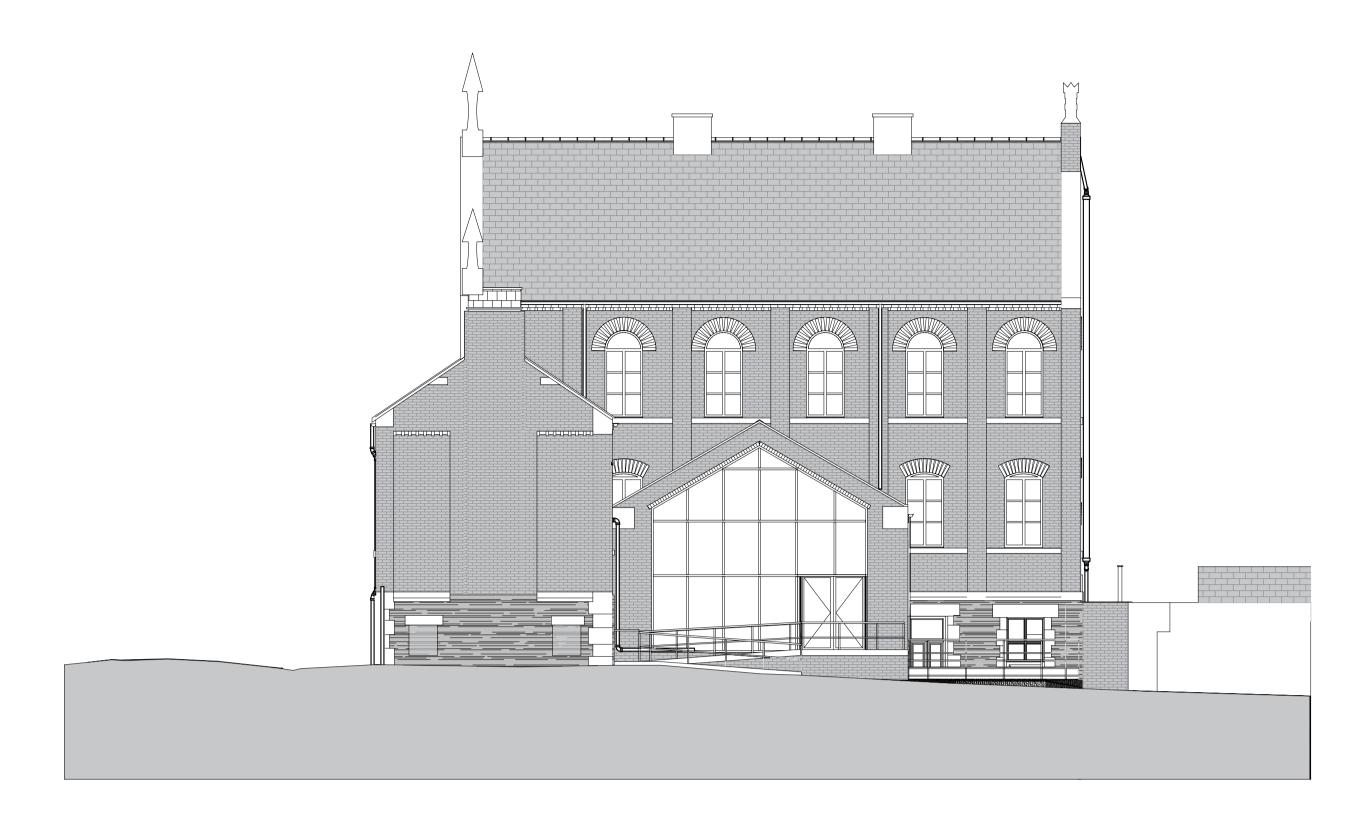






title:

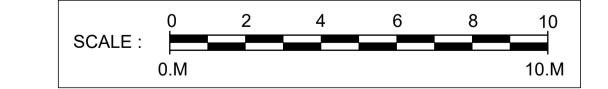

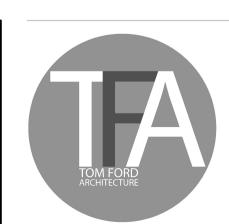

Tom Ford Architecture Ltd 22 Doreen Avenue Congleton, Cheshire

Tom@Tom-Ford-Architecture.com +7794019160 www.Tom-Ford-Architecture.com

notes

- Drawings are based on survey data and may not accurately represent what is physically present.

 Do not scale from this drawing. All dimensions to be site verified by the contractor before proceeding.

 All dimensions are in millimetres unless noted otherwise.
- Tom Ford Architecture Ltd shall be notified in writing of any discrepancies.
- The copyright of this drawing is vested in Tom Ford Architecture Ltd and it may not be reproduced in whole or part or used for the manufacture of any article without the express permission of the copyright
- This drawing is to be read in conjunction with all relevant engineers and consultants drawings and specifications.

DEV	DATE	DRAWN BY	ADDD DV	NOTES	
KEV	DATE	DRAWN BY	APPR. DI	NOTES	

client: Wynne Developments Ltd project: St Georges Baptist Church

status:

revision:

STAGE 3


drawn by:	TJF
approved by:	TJF
date:	16.12.24
job no:	107
scale:	1:100@A1L

Existing Elevations






Tom@Tom-Ford-Architecture.com +7794019160 www.Tom-Ford-Architecture.com

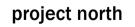

notes

- Drawings are based on survey data and may not accurately represent what is physically present.
- Do not scale from this drawing. All dimensions to be site verified by the contractor before proceeding. All dimensions are in millimetres unless noted otherwise.
- Tom Ford Architecture Ltd shall be notified in writing of any discrepancies.
- The copyright of this drawing is vested in Tom Ford Architecture Ltd and it may not be reproduced in whole or part or used for the manufacture of any article without the express permission of the copyright
- This drawing is to be read in conjunction with all relevant engineers and consultants drawings and specifications.

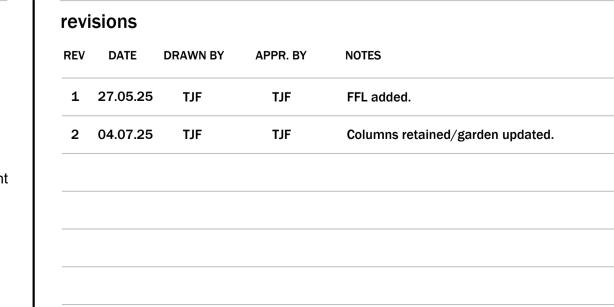


client: **ELIVI Property Group** proje

		Lower Ground Floor		
project:		drawn by:	TJF	
St Georges	Baptist Church	approved by:	TJF	
		date:	19.12.24	
status:	Stage 3	job no:	107	
revision:	2	scale:	1:50@A1L	


title:

Proposed GA Floor Plan

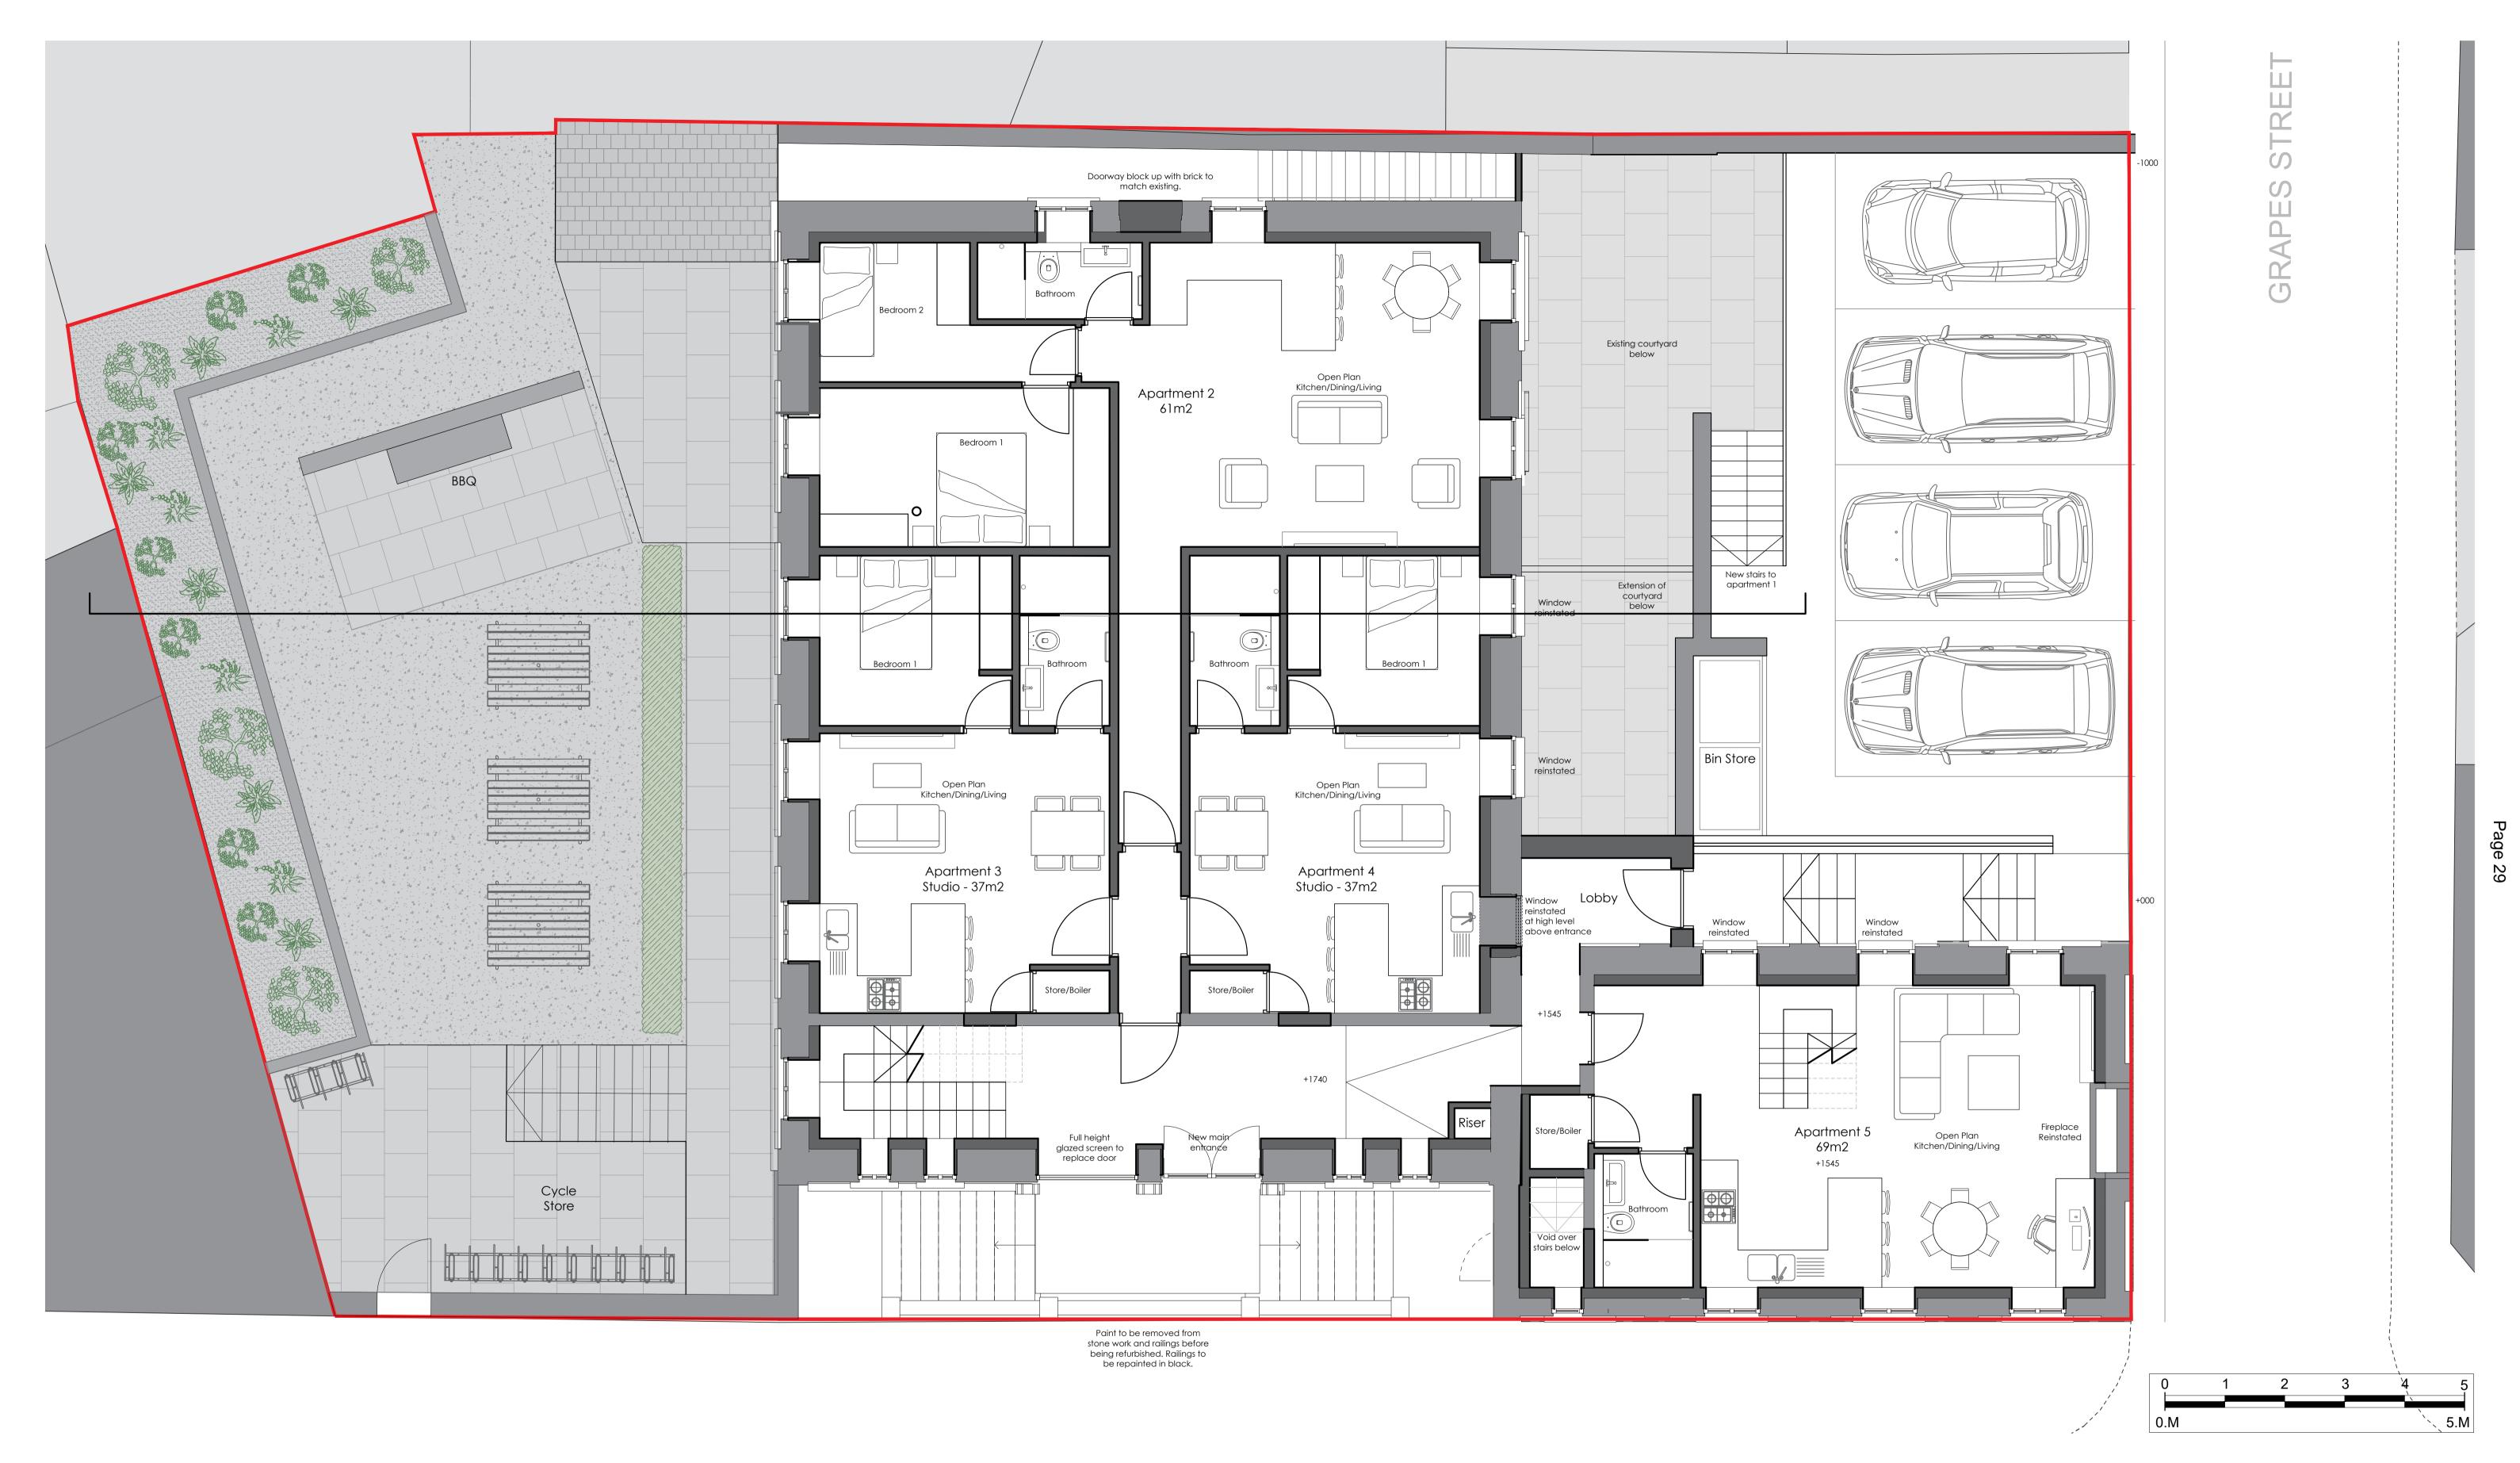




Tom@Tom-Ford-Architecture.com +7794019160 www.Tom-Ford-Architecture.com

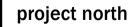

notes

- Drawings are based on survey data and may not accurately represent what is physically present.
- Do not scale from this drawing. All dimensions to be site verified by the contractor before proceeding.
- All dimensions are in millimetres unless noted otherwise.
- Tom Ford Architecture Ltd shall be notified in writing of any discrepancies. The copyright of this drawing is vested in Tom Ford Architecture Ltd and it may not be reproduced in whole or part or used for the manufacture of any article without the express permission of the copyright
- This drawing is to be read in conjunction with all relevant engineers and consultants drawings and specifications.

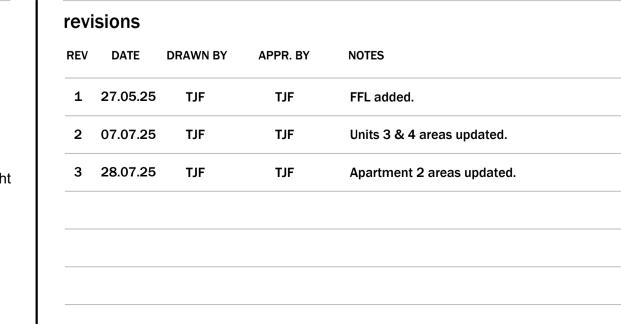

client: **ELIVI Property Group** project: St Georges Bapti

status:


revision:


, ,		Ground Floor
	drawn by:	TJF
tist Church	approved by:	TJF
	date:	19.12.24
Stage 3	job no:	107
3	scale:	1:50@A1L

Proposed GA Floor Plan

title:




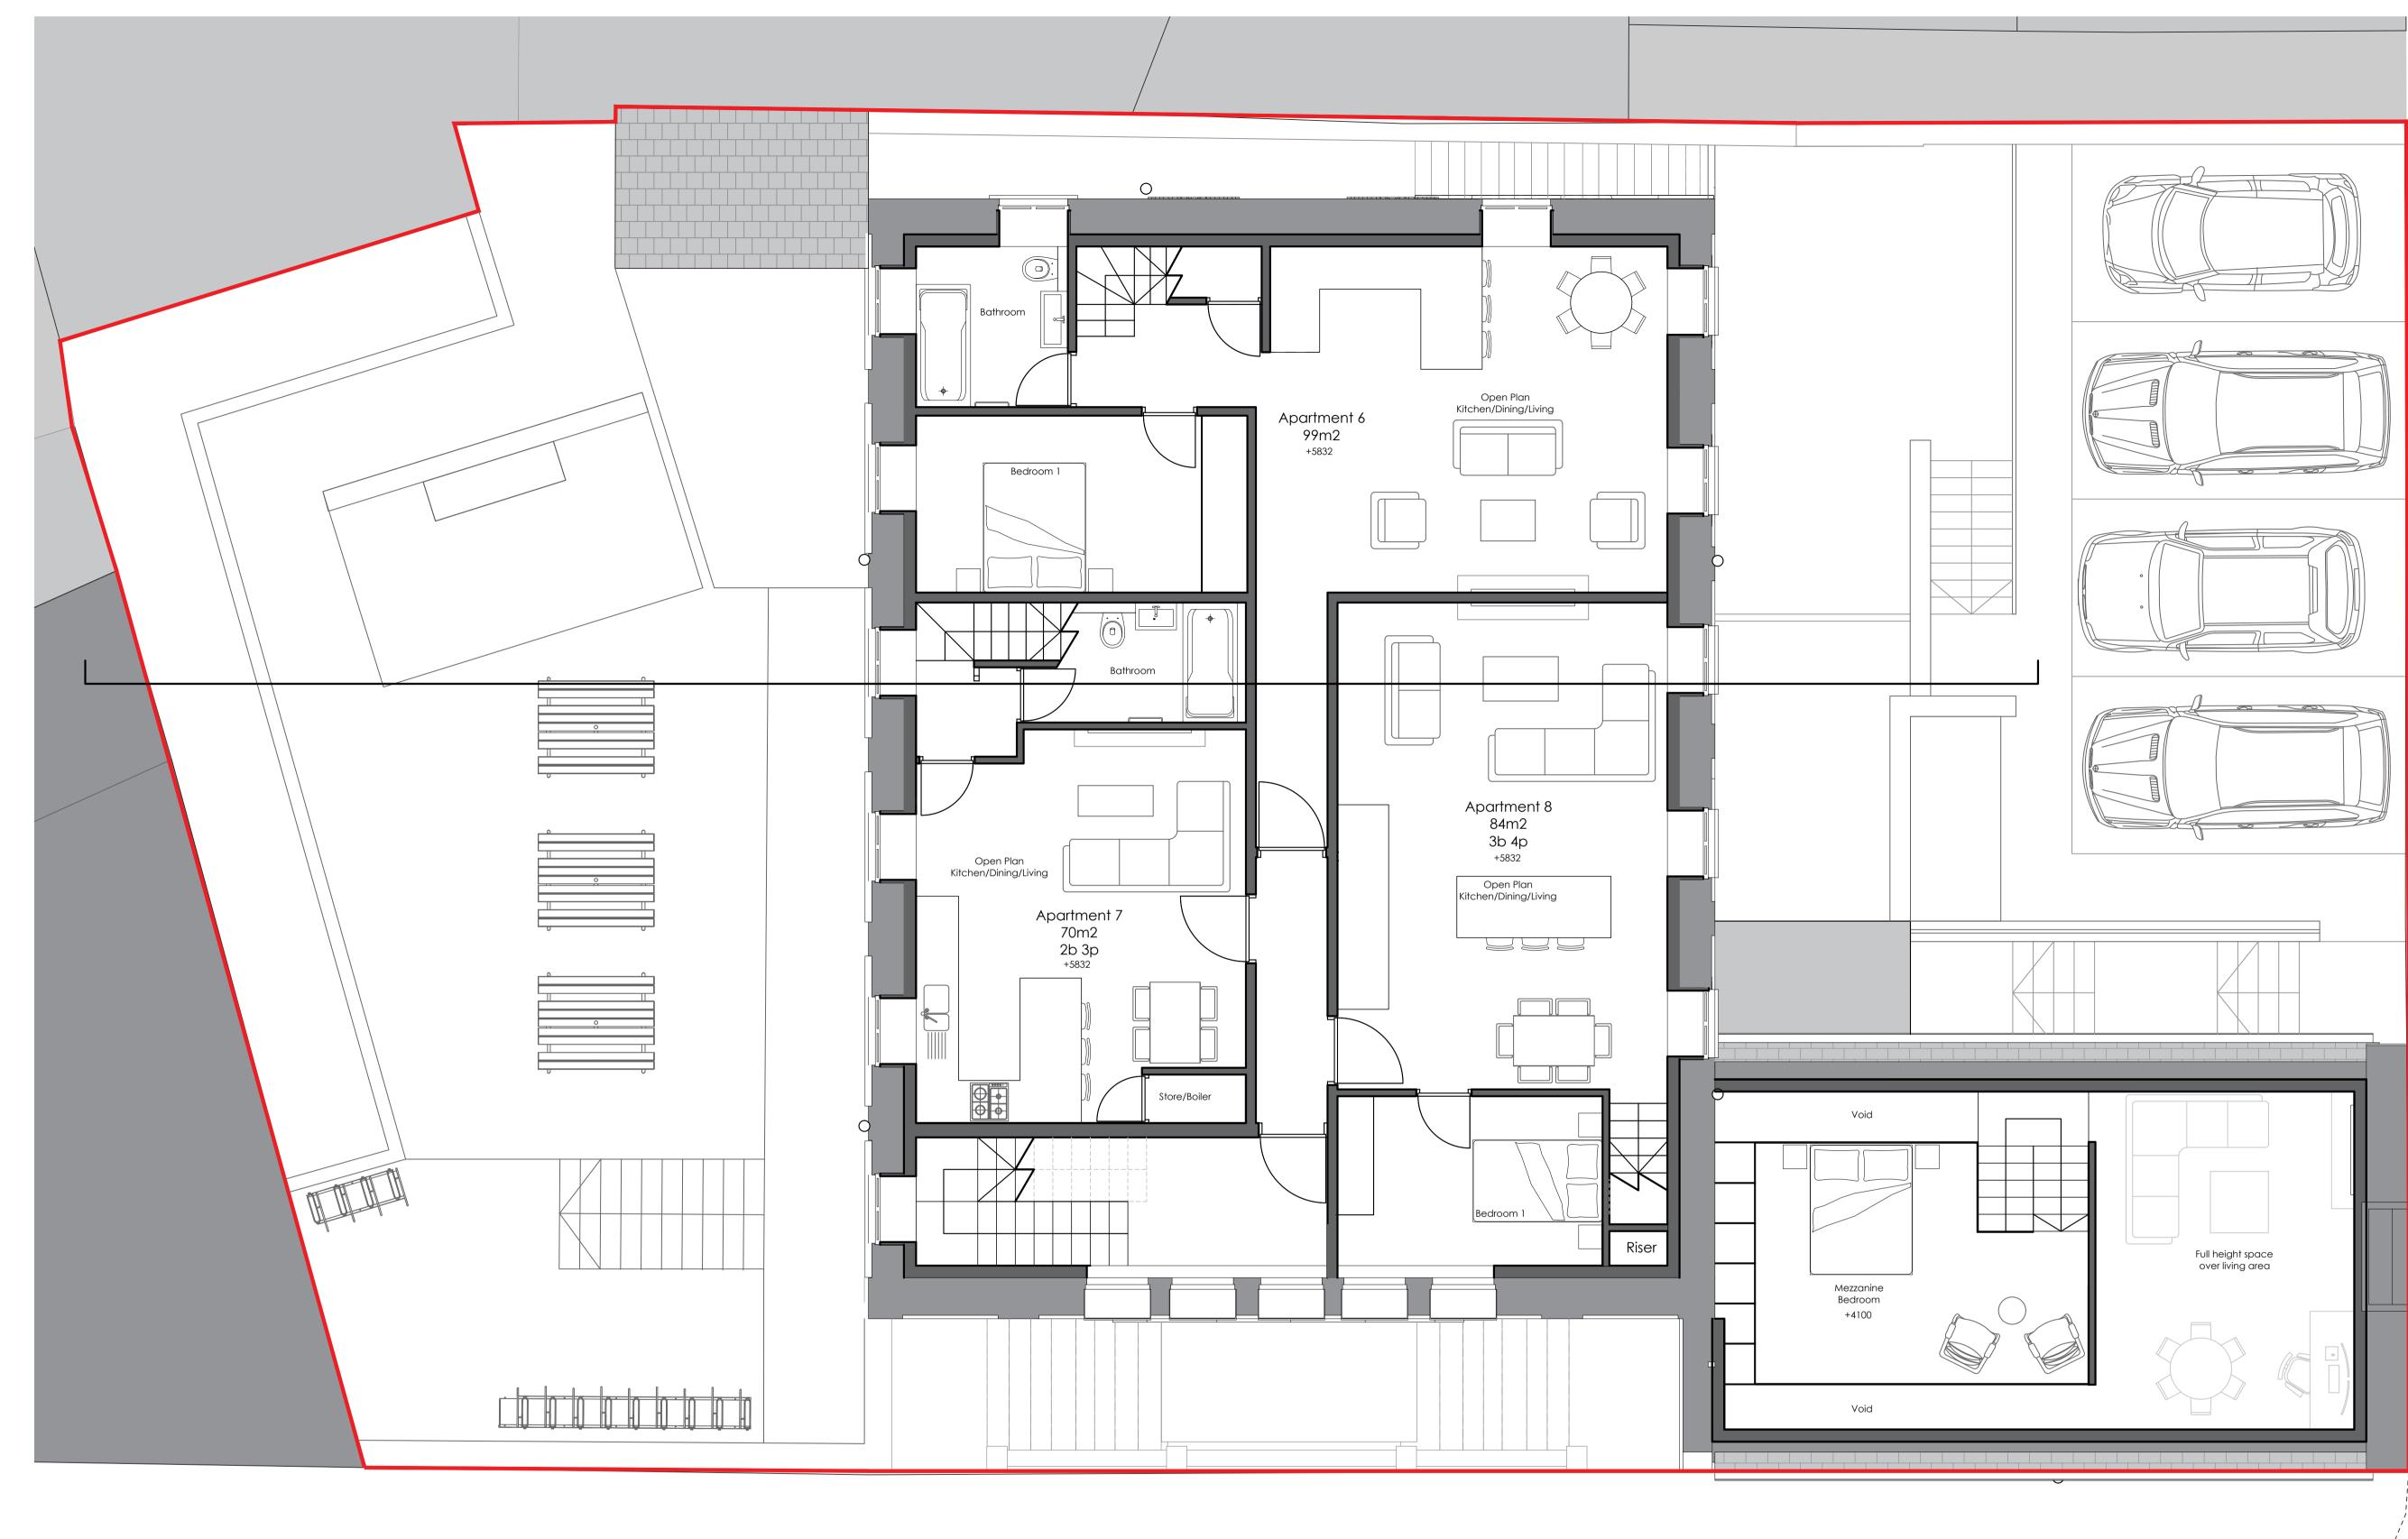

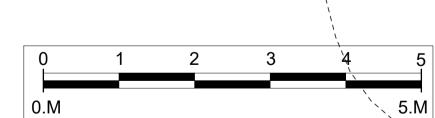




Tom@Tom-Ford-Architecture.com +7794019160 www.Tom-Ford-Architecture.com

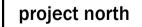

notes

- Drawings are based on survey data and may not accurately represent what is physically present.
- Do not scale from this drawing. All dimensions to be site verified by the contractor before proceeding.
 All dimensions are in millimetres unless noted otherwise.
- All dimensions are in millimetres unless noted otherwise.Tom Ford Architecture Ltd shall be notified in writing of any discrepancies.
- 5. The copyright of this drawing is vested in Tom Ford Architecture Ltd and it may not be reproduced in whole or part or used for the manufacture of any article without the express permission of the copyright
- 6. This drawing is to be read in conjunction with all relevant engineers and consultants drawings and specifications.

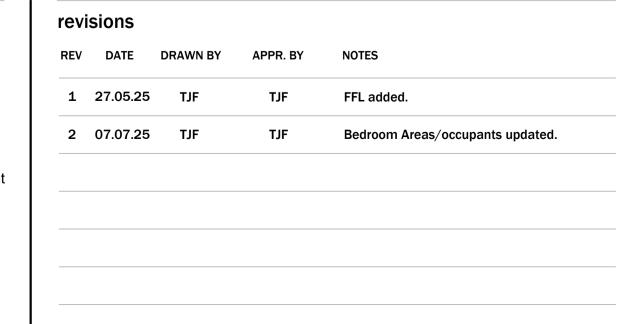

ELIVI Property Group project: St Georges Baptist Church

status:


revision:

Stage 3

Proposed	GA Floor Plan First Floor
drawn by:	TJF
approved by:	TJF
date:	19.12.24
job no:	107
scale:	1:50@A1L

title:




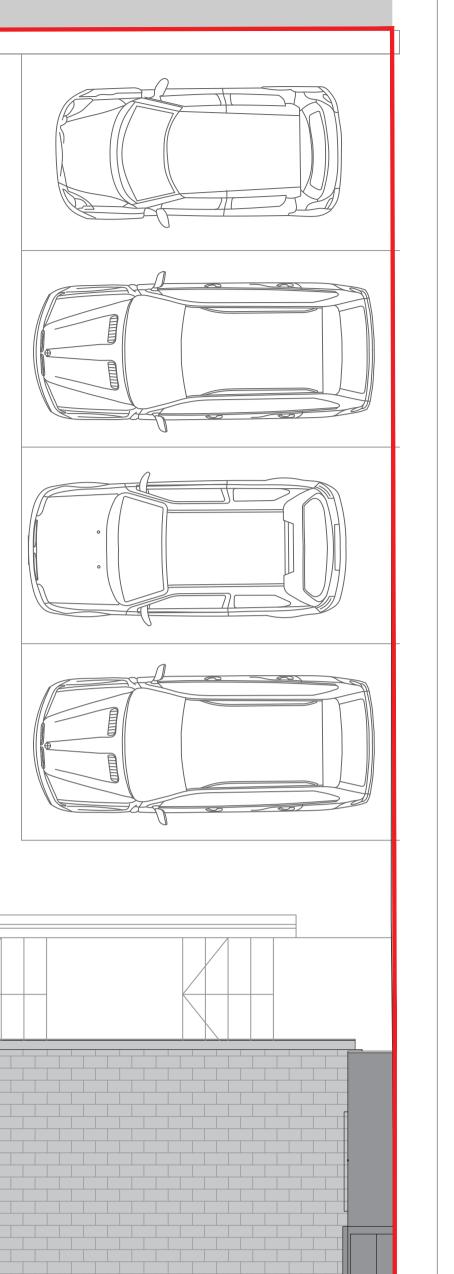





Tom@Tom-Ford-Architecture.com +7794019160 www.Tom-Ford-Architecture.com

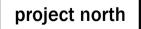

notes

1. Drawings are based on survey data and may not accurately represent what is physically present.

Eaves Store

Eaves Store

- Do not scale from this drawing. All dimensions to be site verified by the contractor before proceeding.
 All dimensions are in millimetres unless noted otherwise.
- All dimensions are in millimetres unless noted otherwise.Tom Ford Architecture Ltd shall be notified in writing of any discrepancies.
- 5. The copyright of this drawing is vested in Tom Ford Architecture Ltd and it may not be reproduced in whole or part or used for the manufacture of any article without the express permission of the copyright
- 6. This drawing is to be read in conjunction with all relevant engineers and consultants drawings and specifications.



Eaves Store

Eaves Store

+9924

ELIVI Property Group project: St Georges Baptist Church

project:		drawn by:	TJF	
St Georges	Baptist Church	approved by:	TJF	
_	-	date:	19.12.24	
status:	Stage 3	job no:	107	
revision:	2	scale:	1:50@A1L	


title:


Proposed GA Floor Plan


Second Floor/Mezzanine

drawing no:


024

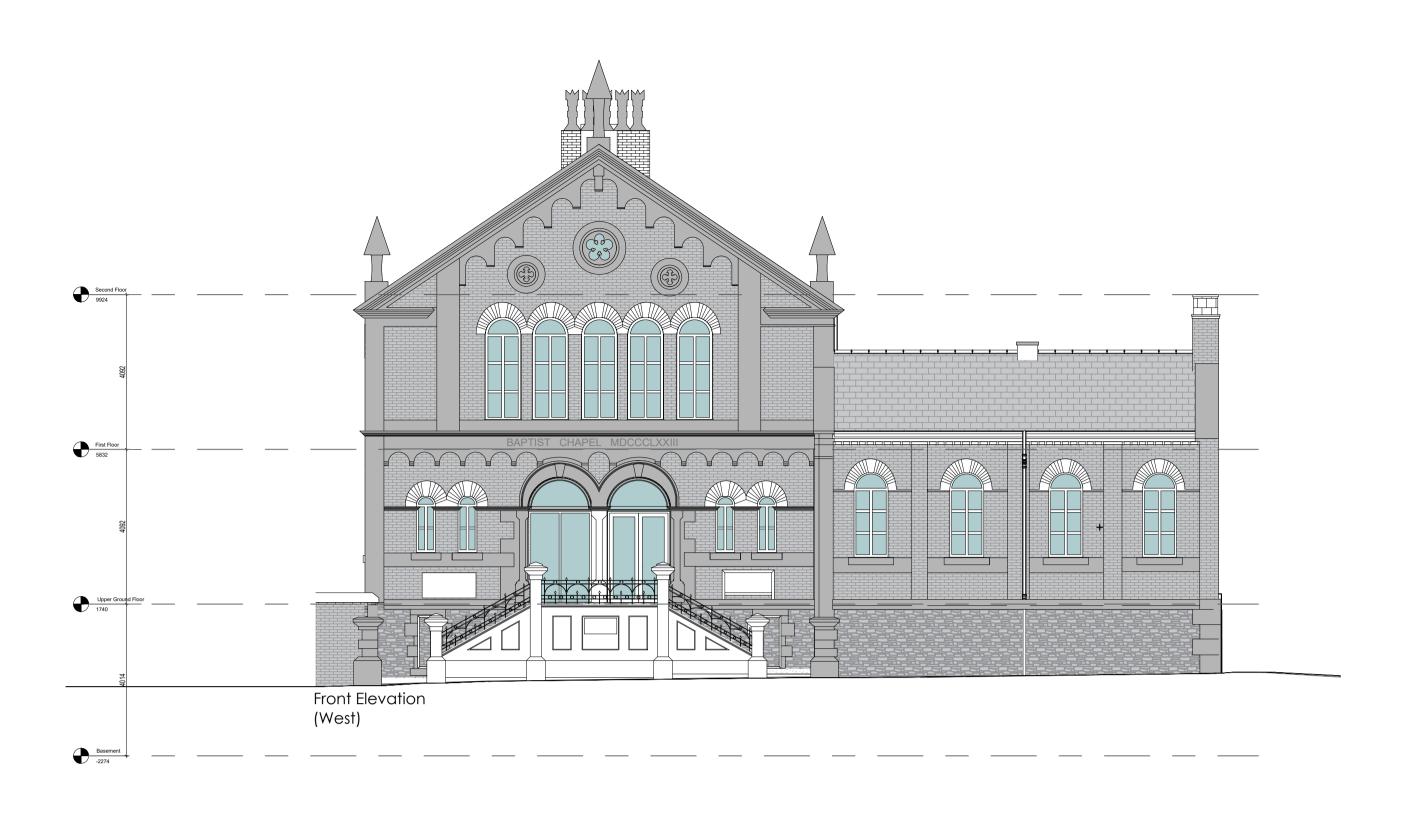

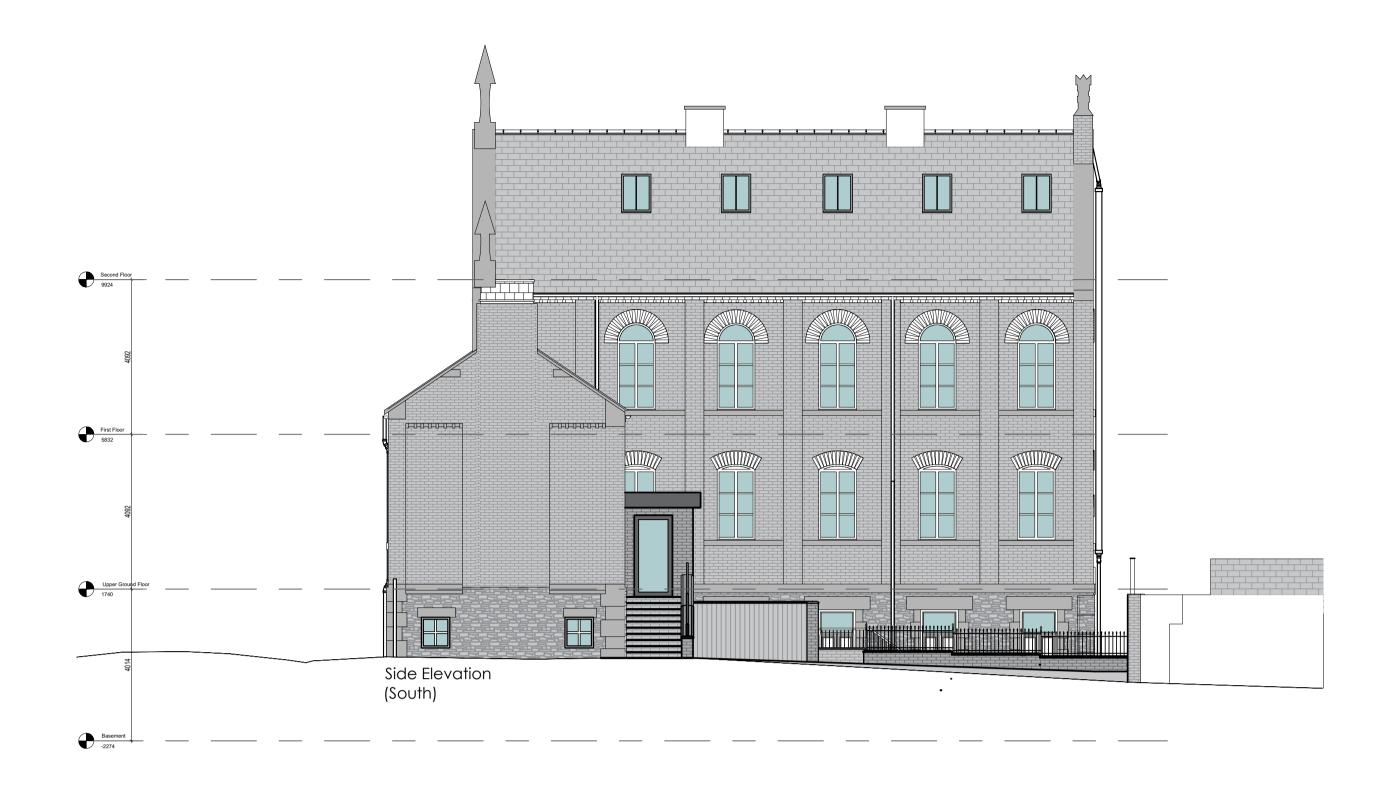

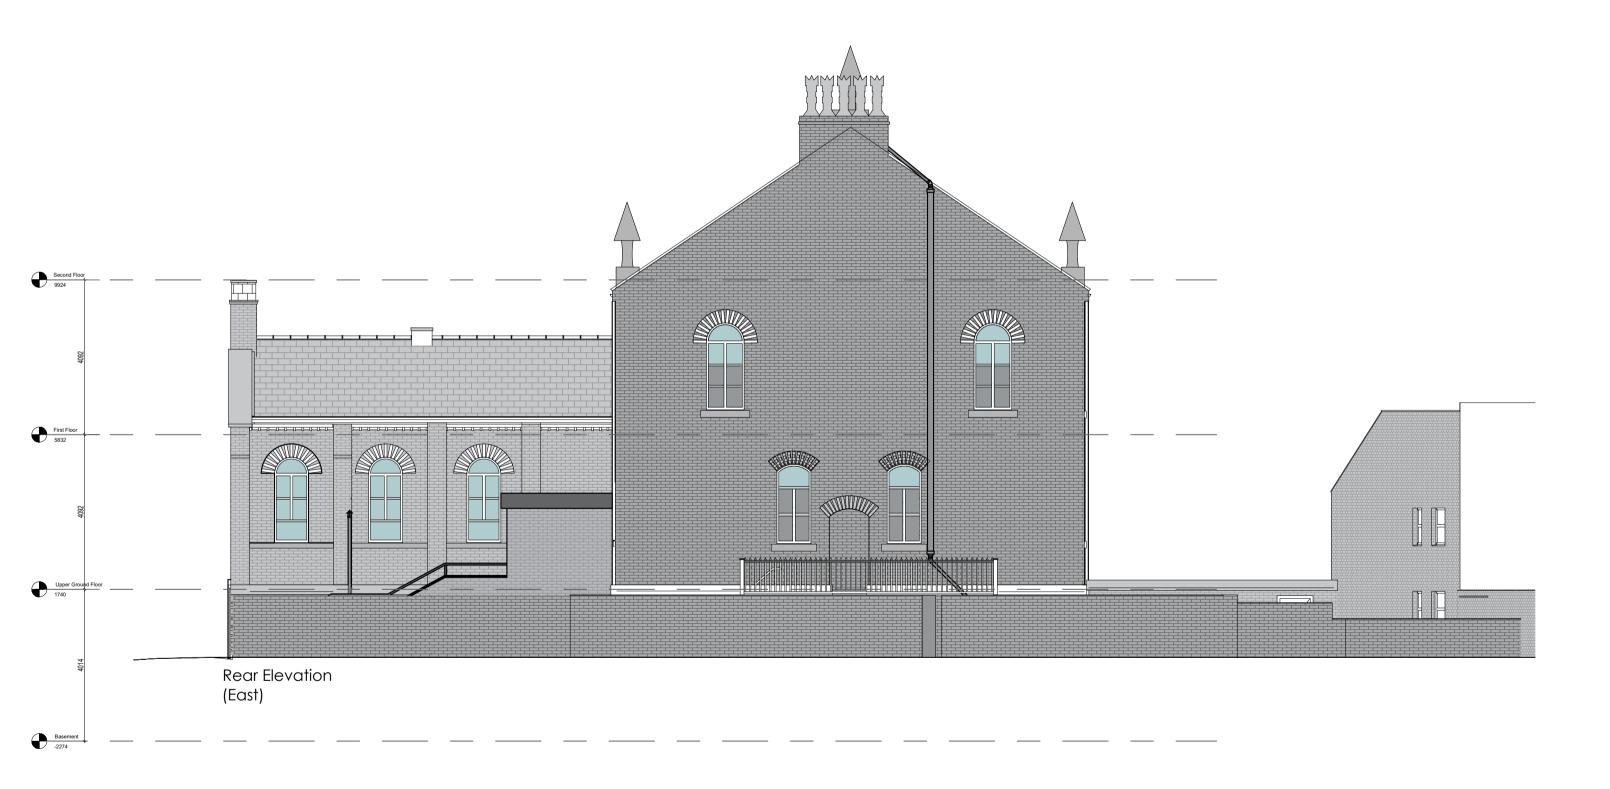



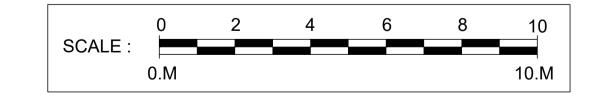



Tom@Tom-Ford-Architecture.com +7794019160 www.Tom-Ford-Architecture.com

notes

- Drawings are based on survey data and may not accurately represent what is physically present.
- 2. Do not scale from this drawing. All dimensions to be site verified by the contractor before proceeding.
- 3. All dimensions are in millimetres unless noted otherwise.
- Tom Ford Architecture Ltd shall be notified in writing of any discrepancies.
 The copyright of this drawing is vested in Tom Ford Architecture Ltd and it may not be reproduced in whole or part or used for the manufacture of any article without the express permission of the copyright
- 6. This drawing is to be read in conjunction with all relevant engineers and consultants drawings and specifications.

REV	DATE	DRAWN BY	APPR. BY	NOTES
1	07.07.25	TJF	TJF	Levels added.

ELIVI Prop	perty Group
project:	
St Georges Bap	otist Church
status:	STAGE 3

titio.	
Prop	osed Elevation
drawn by:	TJ
approved by:	TJ
date:	16.12.2
job no:	10
scale:	1:100@A1

drawing no:

TJF
TJF
24
.07







Tom@Tom-Ford-Architecture.com +7794019160 www.Tom-Ford-Architecture.com

notes

- Drawings are based on survey data and may not accurately represent what is physically present.
- Do not scale from this drawing. All dimensions to be site verified by the contractor before proceeding. All dimensions are in millimetres unless noted otherwise.
- Tom Ford Architecture Ltd shall be notified in writing of any discrepancies.
- The copyright of this drawing is vested in Tom Ford Architecture Ltd and it may not be reproduced in whole or part or used for the manufacture of any article without the express permission of the copyright
- This drawing is to be read in conjunction with all relevant engineers and consultants drawings and specifications.


REV	DATE	DRAWN BY	APPR. BY	NOTES	

client: **ELIVI Property Group** project: St Georges Baptist Church Stage 3

status:

revision:

oposed Section
TJF
TJF
19.12.24
107
1:50@A1L

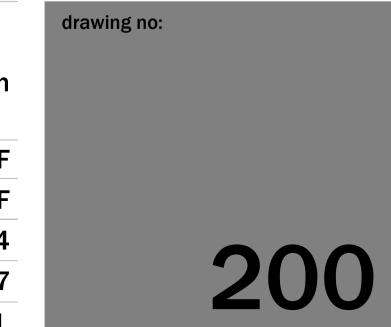

This page is intentionally left blank

25/1947/FUL Sherwood, 33 Adlington Road, Wilmslow, SK9 2BJ



Land at 33 Adlington Road

site Address 33 Adlington Road Wilmslow

POSTCODE SK9 2BJ

site location plan

PROJECT NO. DWG NO. REV NO. 2725 001 A

SCALE 1:1000

drawn by HO CHECKED BY

PLANNING

REV DESCRIPTION

INTL. CHK. DATE

HO AW 15.05.25



Key:

Site boundary

Land in the applicant's control

Site Location Plan

1:1000

0	20m	40m	60m	80m



nc architecture The Island, St. Ann's Parade, Wilmslow, Cheshire SK9 1HG

T: 01625 536 767
E: info@ncarchitecture.com
W: www.ncarchitecture.com

RIBA 🗯



10

20 m

Page 37

nc architecture

RIBA 🗯

Chartered Practice
Architects
Registration
Board

PROJECT
Land at 33 Adlington Road site Address 33 Adlington Road Wilmslow

PLANNING

Proposed Site Plan PROJECT NO. DWG NO. REV NO. 2725 P-051 E

DRAWN BY CHECKED BY

AS NSC

REV DESCRIPTION INTL. CHK. DATE HO 02.04.25 HO AW 24.04.25 HO AW 15.05.25 AS NSC 25.07.25 M AS NSC 08.08.25 A first issue
B updated to suit client comments

SCALE 1:200





SPECIFICATION

EXCAVATION AND TOPSOILING

Topsoil Depths Topsoil depths are to be as follows:-

i) in grass areas 150 mm

ii) in shrub bed areas 400 mm Tree pits are to be 600 x 600 x 600 mm overall depth.

Prior to topsoiling all areas to receive topsoil shall be ripped in two directions to a depth of 300 mm and all stones and debris removed. Topsoil shall be loose tipped and lightly spread using the back of an excavator bucket or by hand where machine work is not possible. After spreading topsoil ensure that any compaction is forked or rotavated out. Topsoiled areas shall be in an uncompacted and uncontaminated state prior to setting out of shrub and grass areas.

If authorized by the Architect prior to the commencement of grassing or planting areas shall be cleared of weed growth. All vegetation shall be collected and removed from site.

Imported Topsoil Imported topsoil shall be obtained from an approved source and shall be clean weed free natural as dug topsoil to BS 3882, free from excessive stone and roots. Re-manufactured soils shall not be acceptable.

PLANTING WORKS Plant material:

All plant material shall be containerised or bare root and in compliance with BS 3936: 1985 Part 1, from an approved source and to satisfaction of the Landscape Architect or Supervising Officer. Plants shall be free from disease and infection, with no damage to bark,

Plants shall be first class representatives of their normal species or varieties and shall have well developed branches and fibrous rooting systems.

Planting Operations

Taking care to avoid damage and disturbance to roots, rootballs or stems, plant all material at the same depth at which it has been previously growing. Excavate plant pits to allow roots to be spread within the pit.

Polythene and other non-perishable containers are to be removed and any badly damaged roots carefully pruned. Dig over beds, breaking up soil and rake off stones over 40 mm in any dimension. Remove all rubbish and weed growth to tip. Allow for spraying out weed growth as necessary.

Plants shall be firmly planted with 50 g of slow release fertilizer such as 'Vitax' plus moist compost mixed in with the backfill, along with A solution of 'Alginure' in water (1:99) should be applied to the shrub bed after planting so that the backfill is well watered in and the plant is firmed into the pit by treading.

All native trees and bare root plants shall receive 'Alginure' root dip prior to planting. Prune back all native hedging or transplants by min 1/3rd following planting.

Planting Operations: Trees

Trees shall be planted into tree pits and well staked with 2 No. stakes and a single cross bar set 600 mm above ground level. Base of tree pits shall be broken up to 300 mm before planting. Prior to backfilling, the soil shall be finely broken down and 200 g of a slow release fertilizer such as 'Vitax' incorporated into the backfill, with tree planting compost (50% by volume).

'Puddle' the backfilled tree pit with a 1:99 solution of 'Alginure' to ensure the tree pit is well watered. Location of tree pits shall be made by the Main Contractor to avoid conflict with underground services.

Following planting all beds shall be forked over, raked level and covered with a 75 mm layer of approved bark mulch. (50 mm compacted depth).

The Maintenance period shall run for a period of 12 months after practical completion and shall be undertaken only during suitable

Tree ties shall be regularly inspected and adjusted during the maintenance period.

Shrub areas shall be kept clear of litter and debris, weeding shall be carried out in shrub beds at each grass cutting visit. Weed control may be carried out in order to promote healthy and vigorous growth. Native shrubs and trees shall be maintained with a 1 m dia weed free area to the base of each plant. Watering shall be carried out during periods of drought or as instructed by the Architect. The landscape sub-contractor will be responsible for the watering of all trees, shrubs and grass areas in order to minimize plant losses.

The sub-contractor shall be responsible for the replacement of any plant material that fails to thrive through fault or omission on behalf of the landscape sub-contractor in the supply, transport, handling, planting operations or maintenance operations, where carried out by

the landscape sub-contractor. Defects works may include the following measures:

1) Dusting, spraying or pruning as necessary. 2) Cutting out dead and damaged wood

Stone picking 4) Making good damaged or dead turf areas 5) Replacement of dead or dying plant material

The planting and maintenance rates in the tender shall be deemed to include for all such costs and no additional payments shall be made for any works under Defects Liability.

TYPICAL TREE PIT DETAIL

Protected RPA zone- hand work only within this area- see Arb report

1.8m ht close board fence

canopy spread

extg tree retained

2m ht brick wall

1m wide bed to parking area

1.8m ht close board fence

with fence trained damson



paved access

//ACADAM

ACCESS ROAD

1.8m ht close board fence

LEGEND



All soft landscape areas for shrub planting to be cleared of debris, decompacted and prepared for planting or turfing, with 400mm depth topsoil. Plants at 3-8no /sqm- see typical planting section All soft landscape areas to be cultivated and planted with shrubs/ perennials and mulched with bark mulch

All grass areas to be provided with min 150mm depth topsoil, decompacted, cultivated and turfed with cultivated grade turf

Entrances to houses paved in London Stone porcelain paving R14 grip rated laid to suppliers instructions

Parking areas paved in Tobermore Hydropave or similar/ permeable block paving

Circulation paths and pedestrian access points surfaced in pcc slab paving to clients choice, sand:cmt mortar bedded on 150mm MOT type gritstone subbase with resin grout pointing to joints

New Feathered - Heavy Standard size tree planting in 0.6m sq x 0.6m deep tree pits. All trees to be planted in Re-root liners to restrict root growth within 4m of any services and buildings or structures.

Planting areas- preparation:

Main Contractor to bring site to formation level being 400mm or 150mm below finished levels to receive topsoil by landscape contractor.

Clear all rubble and debris from areas prior to ripping or rotavating to 300mm depth.

Import clean weed free natural as-dug topsoil to BS 3882 to bring up levels where low and in consultation

Ensure all planted areas are provided with a minimum of 450mm depth topsoil. Rake and minor grade all areas to levels, ensuring soil is min 150mm below dpc levels.

Do not carry out excavation under canopy spread of any trees to be retained which shall be protected by approved Tree Protection fencing erected at canopy edge and maintained in place during the works.

Density/sqm quantity Bed ref Species Pot Vol Size Area Litres cm Chois ya Sundance 45-60 Nepeta mussinnii 20-30 2.5 12 Skimmia rubella 30-45 1.5 Hebe Red Edge 20-30 Rhodo yakk Doc 3L/RB Hebe Red Edge 20-30 1.5 Spiraea Goldmound 30-45 12 20-30 2.6 10 Hebe subalpina Spiraea Goldmound 30-45 2.7 13 Carex Evergold 3.6 10 Hebe Midsummer Beauty 20-32 20-30 2.5 20 Lavandula Hidcote 1.6 12 20-30 Lavandula Hidcote Spiraea Goldmound 30-45 1.8 20-30 Sedum spect Autumn Joy 2.9 15 1.2 20-30 Hebe Red Edge 12 20-30 Nepeta mussinni Choisya Sundance 45-60 4.3 12 Coto. conspicuus Decorus 30-45 33 20-32 Hebe Midsummer Beauty 24 Lavatera Barnsley 30-45 Osmanthus x burkwoodii 30-45 1NO. Damson wall trained 15L 1.2-1.8mht 1NO. Liquidamabar Styraciflua Sel Std 10-12 cm 1NO. Prunus subhirtella autumnalis Std 8-10cm 3-3.5m ht 10-12cm g 3-3.5m ht Sorbus aria Lutescens Sel Std 1NO. 10-12cm g 3-3.5m ht 1NO. Sorbus aria Lutescens Sel Std


PLANT KEY AND SCHEDULE

drawing title landscape proposals Land adjacent to 33 Adlington Rd, SK9 2BJ date May 2025 scale 1:200 at A1 drawing no. M25/ 1706 / L01


FFC Landscape Architects landscape and garden design consultants


Forward House, 17 High St, Henley in Arden 32 Stoke Business Centre, Hanley, Staffs Wooster Cottage, Gilberts End Lane, Hanley Castle, Malvern, Worcs tel 01782 791506/ 07960 772307 Email ffclandscapearchitects@gmail.com


FFC Landscape Architects Landscape and Garden Design Consultants

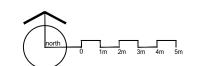


nc architecture

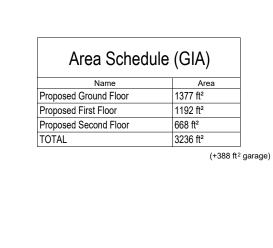

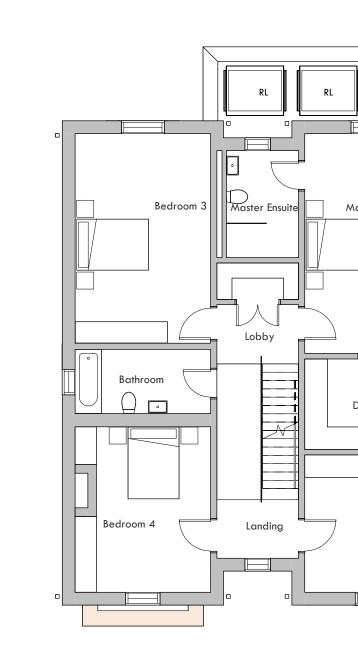


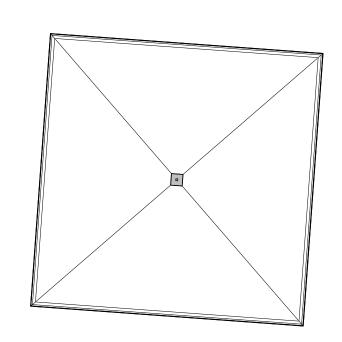


Proposed First Floor Plan
1:100

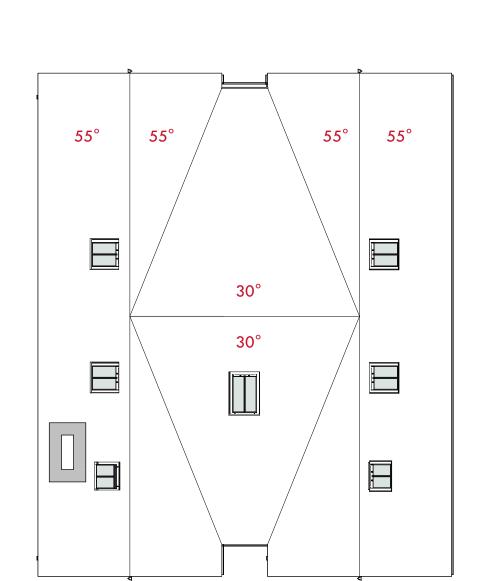


Proposed Roof Plan
1:100

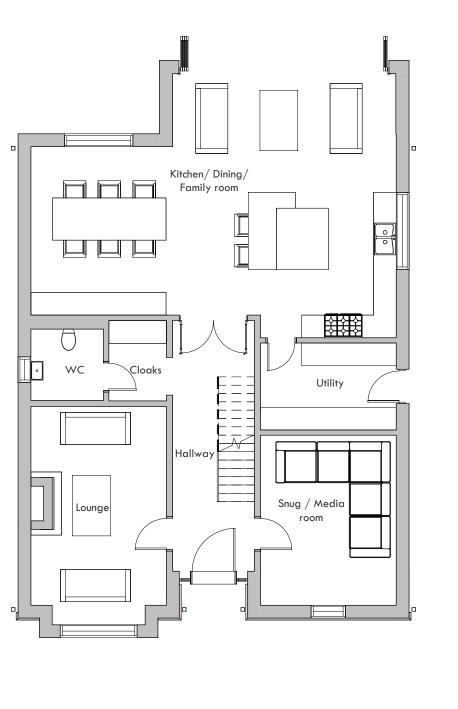

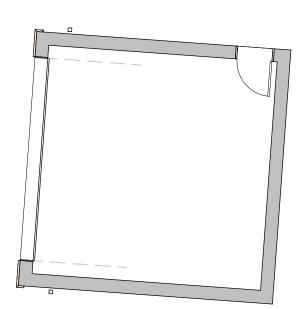

Proposed Ground Floor Plan

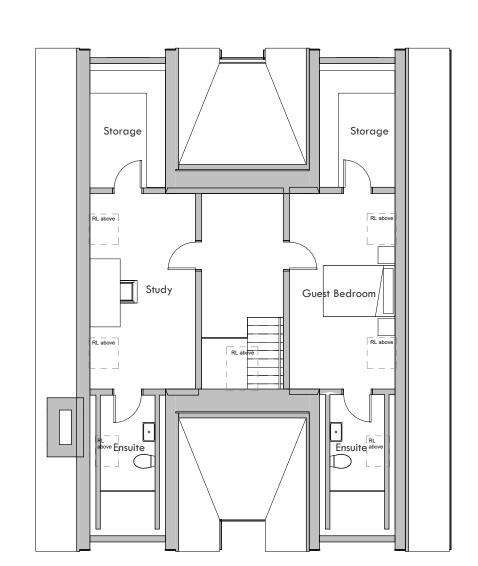

Proposed Second Floor Plan

Land at 33 Adlington Road

SITE ADDRESS
33 Adlington Road

Wilmslow

PLANNING

A Updated scheme first issue HO AW 08.05.25
B Layout changes to suit client HO 14.05.25
comments

Plot.A Elevations



Front Elevation
1:100




side (L) Elevation




side (R) Elevation




Rear Elevation
1:100

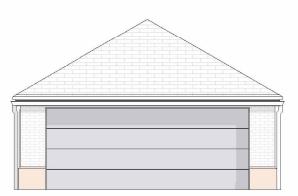


Garage Front Elevation.

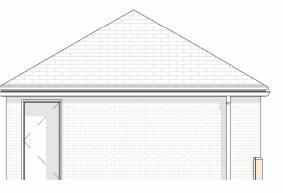

Garage Side (L) Elevation.

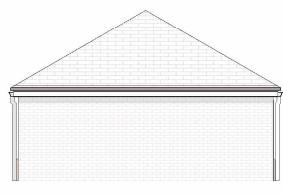


Garage Rear Elevation.

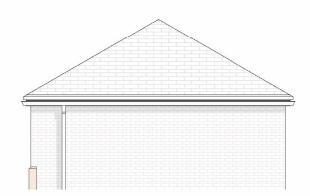


Garage side (R) Elevation.

REV	DESCRIPTION	INTL. CHK. DATE
Α	Updated scheme first issue	HO AW 08.05.2
В	Layout changes to suit client comments	HO 14.05.2
С	Updated location of houses	AS NSC 25.07.2 M




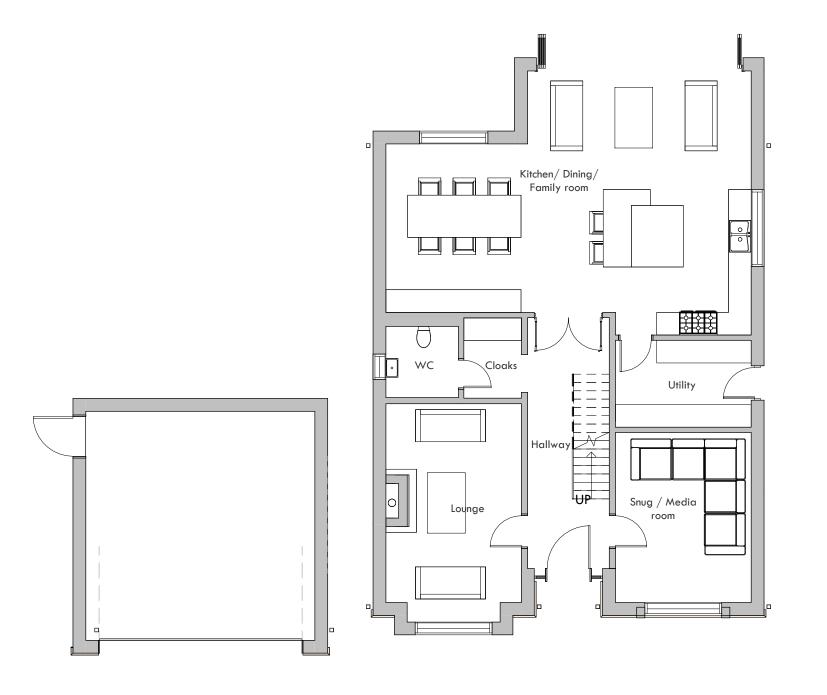


Proposed Ground Floor Plan
1:100

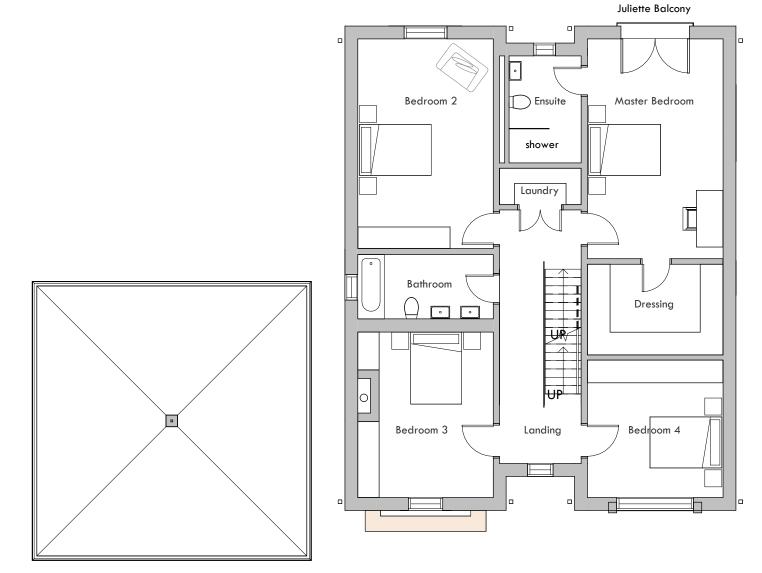

Proposed First Floor Plan
1:100

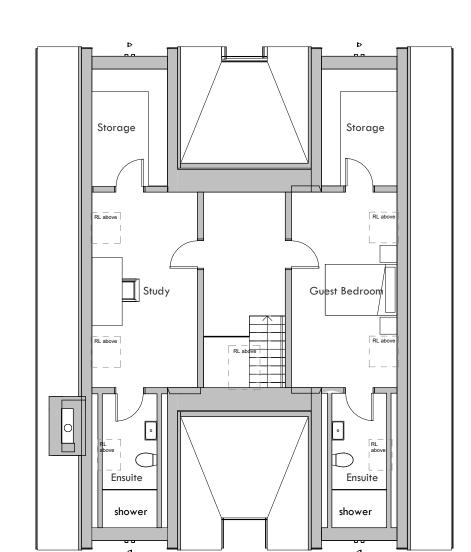

Proposed Second Floor Plan
1:100

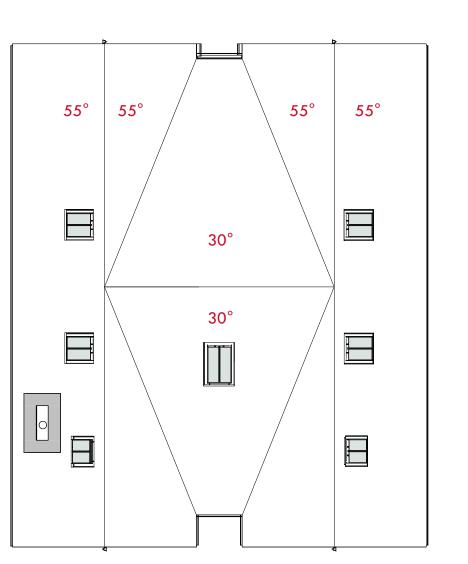

Proposed Roof Plan
1:100

nc architecture

PLANNING

A Updated scheme first issue HO AW 08.05.25
B Layout changes to suit client Comments
C Updated location of houses AS NSC 25.07.25

33 Adlington Road
SITE ADDRESS
33 Adlington Road
Wilmslow

Plot.B Elevations

PROJECT NO. DWG NO. REV NO. 2725 P-210 C
DRAWN BY CHECKED BY ASM NSC

REV DESCRIPTION







side (L) Elevation
1:100




side (R) Elevation
1:100



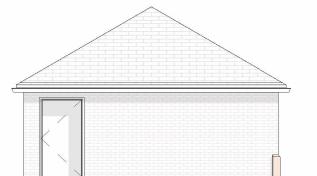

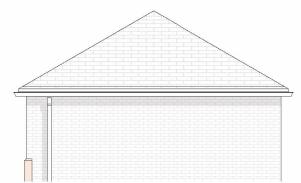

Garage Elevations
1:100

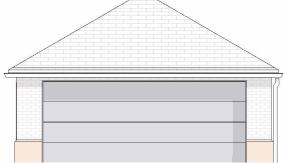

This page is intentionally left blanl